


KEY PLAN SCALE: N.T.S.

CR_6996 ATTACHMENT 3

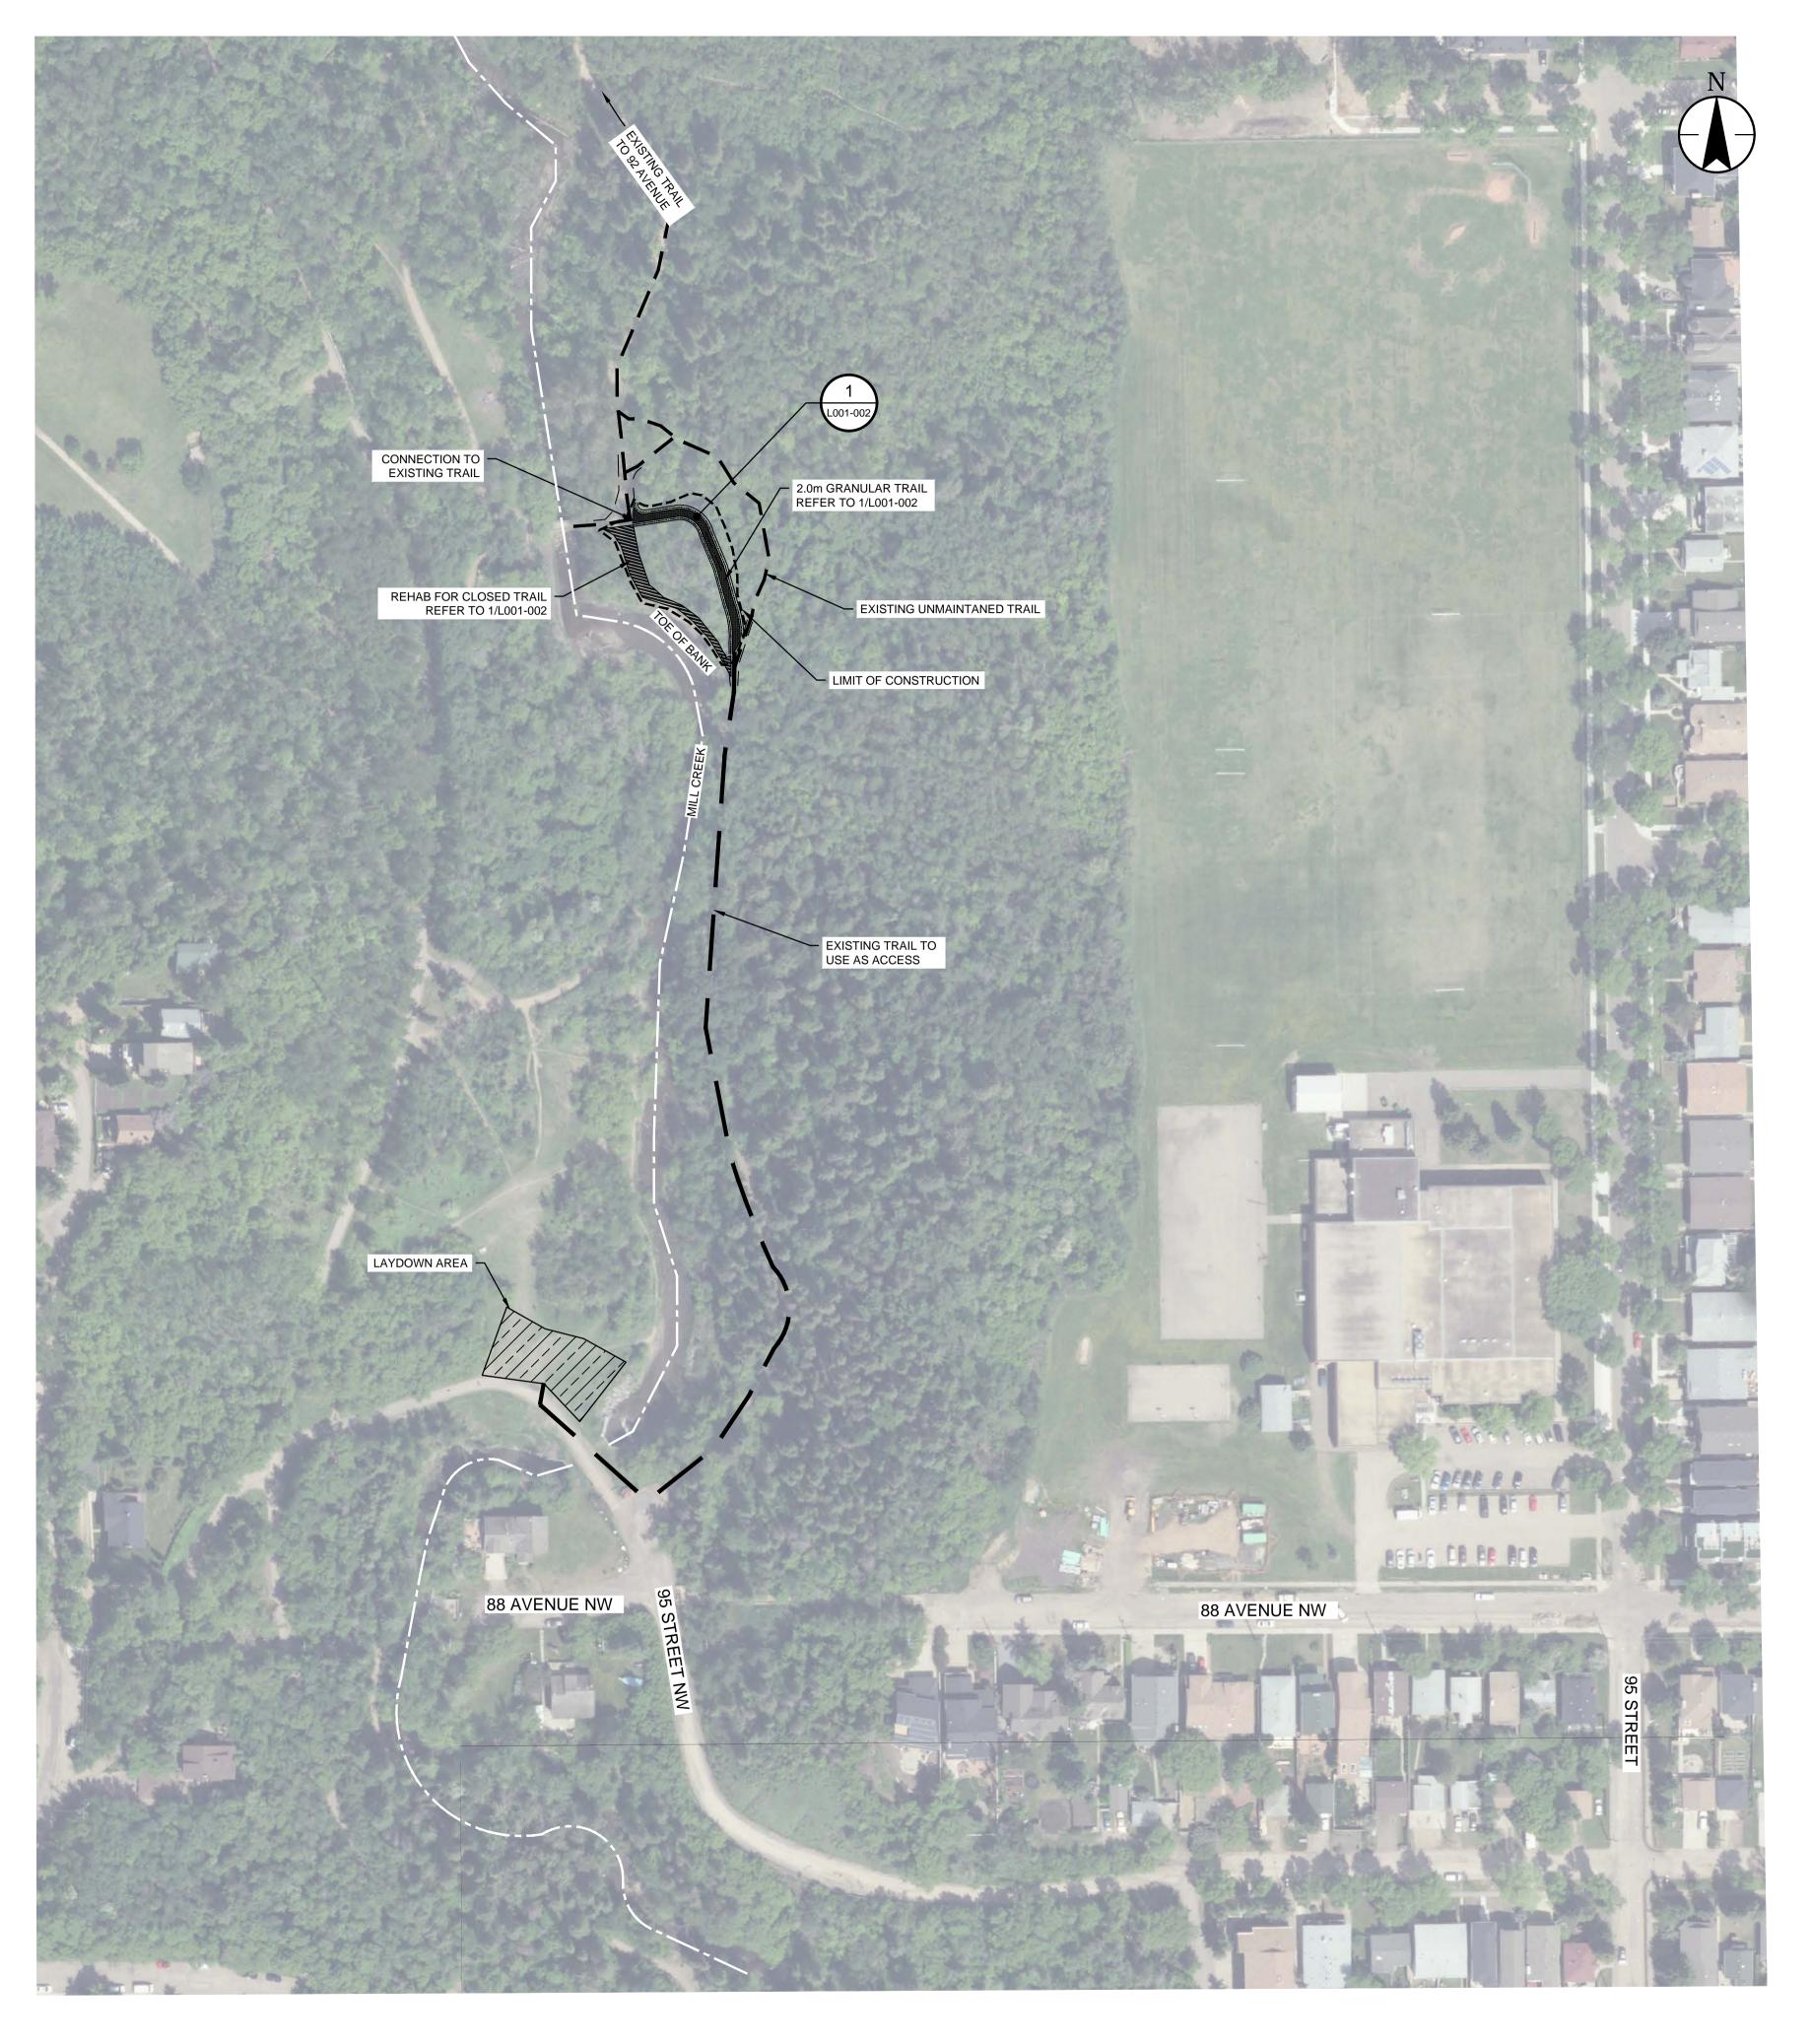

1 SITE #1 OVERALL PLAN
SCALE: 1:1000



Stantec Consulting 10160 - 112 Street Edmonton AB Canada Tel. 780.917.7000

www.stantec.com

Copyright Reserved

The Contractor shall verify and be responsible for all dimensions. DO NOT scale the drawing - any errors or omissions shall be reported to Stantec without delay. The Copyrights to all designs and drawings are the property of Stantec. Reproduction or use for any purpose other than that authorized by Stantec is forbidde

Legend

DETAIL REFERENCE SYMBOL

1
DETAIL NUMBER
SHEET NUMBER

---- LIMIT OF CONSTRUCTION

Notes

UTILITY SETBACKS

LANDSCAPE CONTRACTOR TO CALL 'ALBERTA ONE-CALL' AT 1-800-242-3447 TO HAVE ALL EXISTING SITE UTILITIES LOCATED PRIOR TO CONSTRUCTION AND PLANT NO CLOSER THAN THE FOLLOWING DIMENSIONS FROM THE SERVICES:

- 1.0 m FROM POWER LINES
- 3.5 m FROM ALL POWER HARDWARE1.8 m FROM WATER MAINS, WATER VALVES, MANUAL
- AIRVENTS, AND SERVICES
- 2.0 m FROM SEWER MAINS, AND MANHOLES1.8 m FROM SEWER SERVICES
- 1.5 m FROM GAS (NO TREES WITHIN EASEMENT)7.5 m FROM STREET CORNERS.
- 8. 3.5 m FROM FIRE HYDRANTS.
- 9. 1.5 m FROM DRIVEWAYS
- 0. 1.5 m FROM ALLEY ACCESSES
- . 1.0 m FROM SIDEWALKS OR AS PER APPROVED ENG. CROSS SECTIONS
- 12. 3.5 m FROM TRANSIT ZONES
- 13. 3.0 m FROM PRIVATE PROPERTY BOUNDARY
- 1. 1.25 m FROM COLLECTOR ROAD CURB FACE
- 15. 1.25 m FROM LOCAL ROAD CURB FACE
- 16. 2.0 m FROM ARTERIAL ROAD CURB FACE17. 3.5 m FROM YIELD AND STOP SIGNS
- 18. 3.5 m FROM BUS STOP SIGNS
- 19. 2.0 m FROM ALL OTHER SIGNS20. 1.0 m FROM OTHER UNDERGROUND UTILITIES
- 21. 3.5 m FROM TELUS PEDESTALS
- 22. 2.0 m FROM TELUS DUCT STRUCTURE23. 1.0 m FROM TELUS CABLE FACILITIES

LANDSCAPE CONTRACTOR IS RESPONSIBLE FOR DAMAGES AND

Development Engineer, Sustainable Deve	elopment			
Approvals				YY.MM.DD
Revision		Ву	Appd.	YY.MM.DD
1. FIRST SUBMISSION (60%)		DW	NGS	18.05
Issued		Ву	Appd.	YY.MM
		СВ	NGS	18.03.13
File Name: LA_MillCreek.dwg				

Permit-Seal



Client/Project

CITY OF EDMONTON

MILL CREEK RAVINE PARK TRAIL REHABILITATION

Edmonton, Alberta

Title

SITE #1 OVERALL PLAN

Project No.

1161106255

Scale 0 10 20 30 40 50 1:1000 1:1000 1:1000 Drawing No.

2019-3-18 2:02pm BY: DWIGGLESWORTH 1 of 10

L001-001




SCALE: N.T.S.

LAYOUT AND GRADING NOTES:

- CONTRACTOR TO CALL ALBERTA ONE CALL AT 1-800-242-3447 TO HAVE EXISTING UTILITIES LOCATED PRIOR TO START OF ANY CONSTRUCTION.
- 2. THIS DRAWING IS TO BE READ IN CONJUNCTION WITH THE WRITTEN SPECIFICATIONS, DRAWINGS, AND DETAILS FOR THE PROJECT.
- 3. CONTRACTOR TO ENSURE THAT ALL NECESSARY ARRANGEMENTS ARE MADE WITH THE PIPELINE COMPANIES CONCERNING THE MOVEMENT OF MATERIALS AND EQUIPMENT NEAR ANY PIPELINE RIGHTS OF
- 4. CONTRACTOR IS RESPONSIBLE FOR THE HOARDING OF ALL TREES WITHIN OR ADJACENT TO
- 5. CONTRACTOR IS RESPONSIBLE FOR THE ADJUSTMENT OF ALL EXISTING CATCHBASINS, CATCHBASIN MANHOLES, MANHOLES, WATER VALVES, HYDRANTS, ETC. TO MATCH PROPOSED GRADES.
- 6. ENSURE POSITIVE DRAINAGE IN ALL SWALES AS SHOWN ON PLAN. DO NOT PERMIT POOLING OF WATER IN DRAINAGE SWALE.
- CONTRACTOR IS RESPONSIBLE FOR HAULING OF ALL EXCESS MATERIALS OFF THE SITE.
- CONTRACTOR IS RESPONSIBLE FOR GENERAL SITE CLEAN UP.
- 9. CONTRACTOR IS RESPONSIBLE FOR ANY DAMAGE TO LANDSCAPED AREAS AND MUST MAKE ALL
- NECESSARY RESTORATIONS AND REPAIRS. 10. ALL ANCILLARY WORK NORMALLY ASSOCIATED WITH THIS TYPE OF CONSTRUCTION SHALL BE DEEMED TO
- BE PART OF THE CONTRACT. 11. ALL QUANTITIES ARE APPROXIMATE ONLY.

ARCHITECT.

- 12. GRADES TO BE APPROVED BY LANDSCAPE ARCHITECT PRIOR TO CONSTRUCTION STARTING.
- 13. CONTRACTOR TO HOLD ROUGH GRADES 450 mm BELOW FINISHED GRADE FOR PLANT BEDS, 150mm FOR SEEDED AREAS, 200 mm FOR WALKS, 100 mm FOR SODDED AREAS.
- 14. STANDARD CONTOUR INTERVAL IS 500mm. SPOT ELEVATIONS AS SHOWN. ALL SPOT ELEVATIONS IN METERS. BERMS AND SLOPES TO BE GRADED SMOOTHLY. ELIMINATE ROUGH SPOTS AND LOW AREAS TO ENSURE POSITIVE DRAINAGE PRIOR TO SEEDING.
- 15. ALL PROPOSED GRADES TO MEET EXISTING GRADES AT PROPERTY LINE WITH A SMOOTH TRANSITION. LIMIT OF GRADING NOT TO EXTEND BEYOND PROPERTY LINE. GRADES TO MEET CURB OR WALK SMOOTHLY. LANDSCAPE ARCHITECT TO APPROVE ROUGH AND FINISHED GRADES.
- 16. MAXIMUM SLOPE OF ANY LANDSCAPED AREA NOT TO EXCEED 33%.
- 17. CONTRACTOR TO TAKE NECESSARY PRECAUTIONS TO PROTECT ALL SITE FEATURES EXISTING AT THE TIME OF CONSTRUCTION UNLESS SPECIFIED FOR DEMOLITION ON THE DRAWING. THIS INCLUDES ALL SURVEY BARS, STAKES OR MONUMENTS. MAKE GOOD ANY DAMAGE.
- 18. ANY AMBIGUITY IN THIS DRAWING OR ACCOMPANYING DETAILS IS TO BE REPORTED TO THE LANDSCAPE
- ARCHITECT FOR DIRECTION. CONTRACTOR NOT TO PROCEED IN UNCERTAINTY. 19. LIMITS OF WORK TO BE CLEARLY UNDERSTOOD BY THE CONTRACTOR PRIOR TO ANY WORK TAKING PLACE
- ON SITE. CONTRACTOR TO CONTACT LANDSCAPE ARCHITECT FOR CLARIFICATION IF REQUIRED. 20. CONTRACTOR TO VISIT SITE TO CONFIRM ALL SITE CONDITIONS PRIOR TO SUBMITTING BIDS.
- DISCREPANCIES TO BE REPORTED TO LANDSCAPE ARCHITECT FOR CLARIFICATION. 21. CONTRACTOR TO VERIFY ALL DIMENSIONS AND REPORT ANY DISCREPANCIES TO THE LANDSCAPE
- ARCHITECT.
- 22. LAYOUT TO BE APPROVED BY LANDSCAPE ARCHITECT PRIOR TO CONSTRUCTION STARTING. 23. ALL MEASUREMENTS ARE IN METERS UNLESS OTHERWISE NOTED.
- 24. CONTRACTOR SHALL SUPPLY ALL MATERIALS IN QUANTITIES SUFFICIENT TO COMPLETE WORK SHOWN ON THESE DRAWINGS. ANY DISCREPANCIES SHALL BE REPORTED TO THE LANDSCAPE ARCHITECT FOR
- 25. NO SUBSTITUTIONS OF MATERIALS, PRODUCTS OR QUANTITIES WITHOUT PRIOR CONSENT OF LANDSCAPE

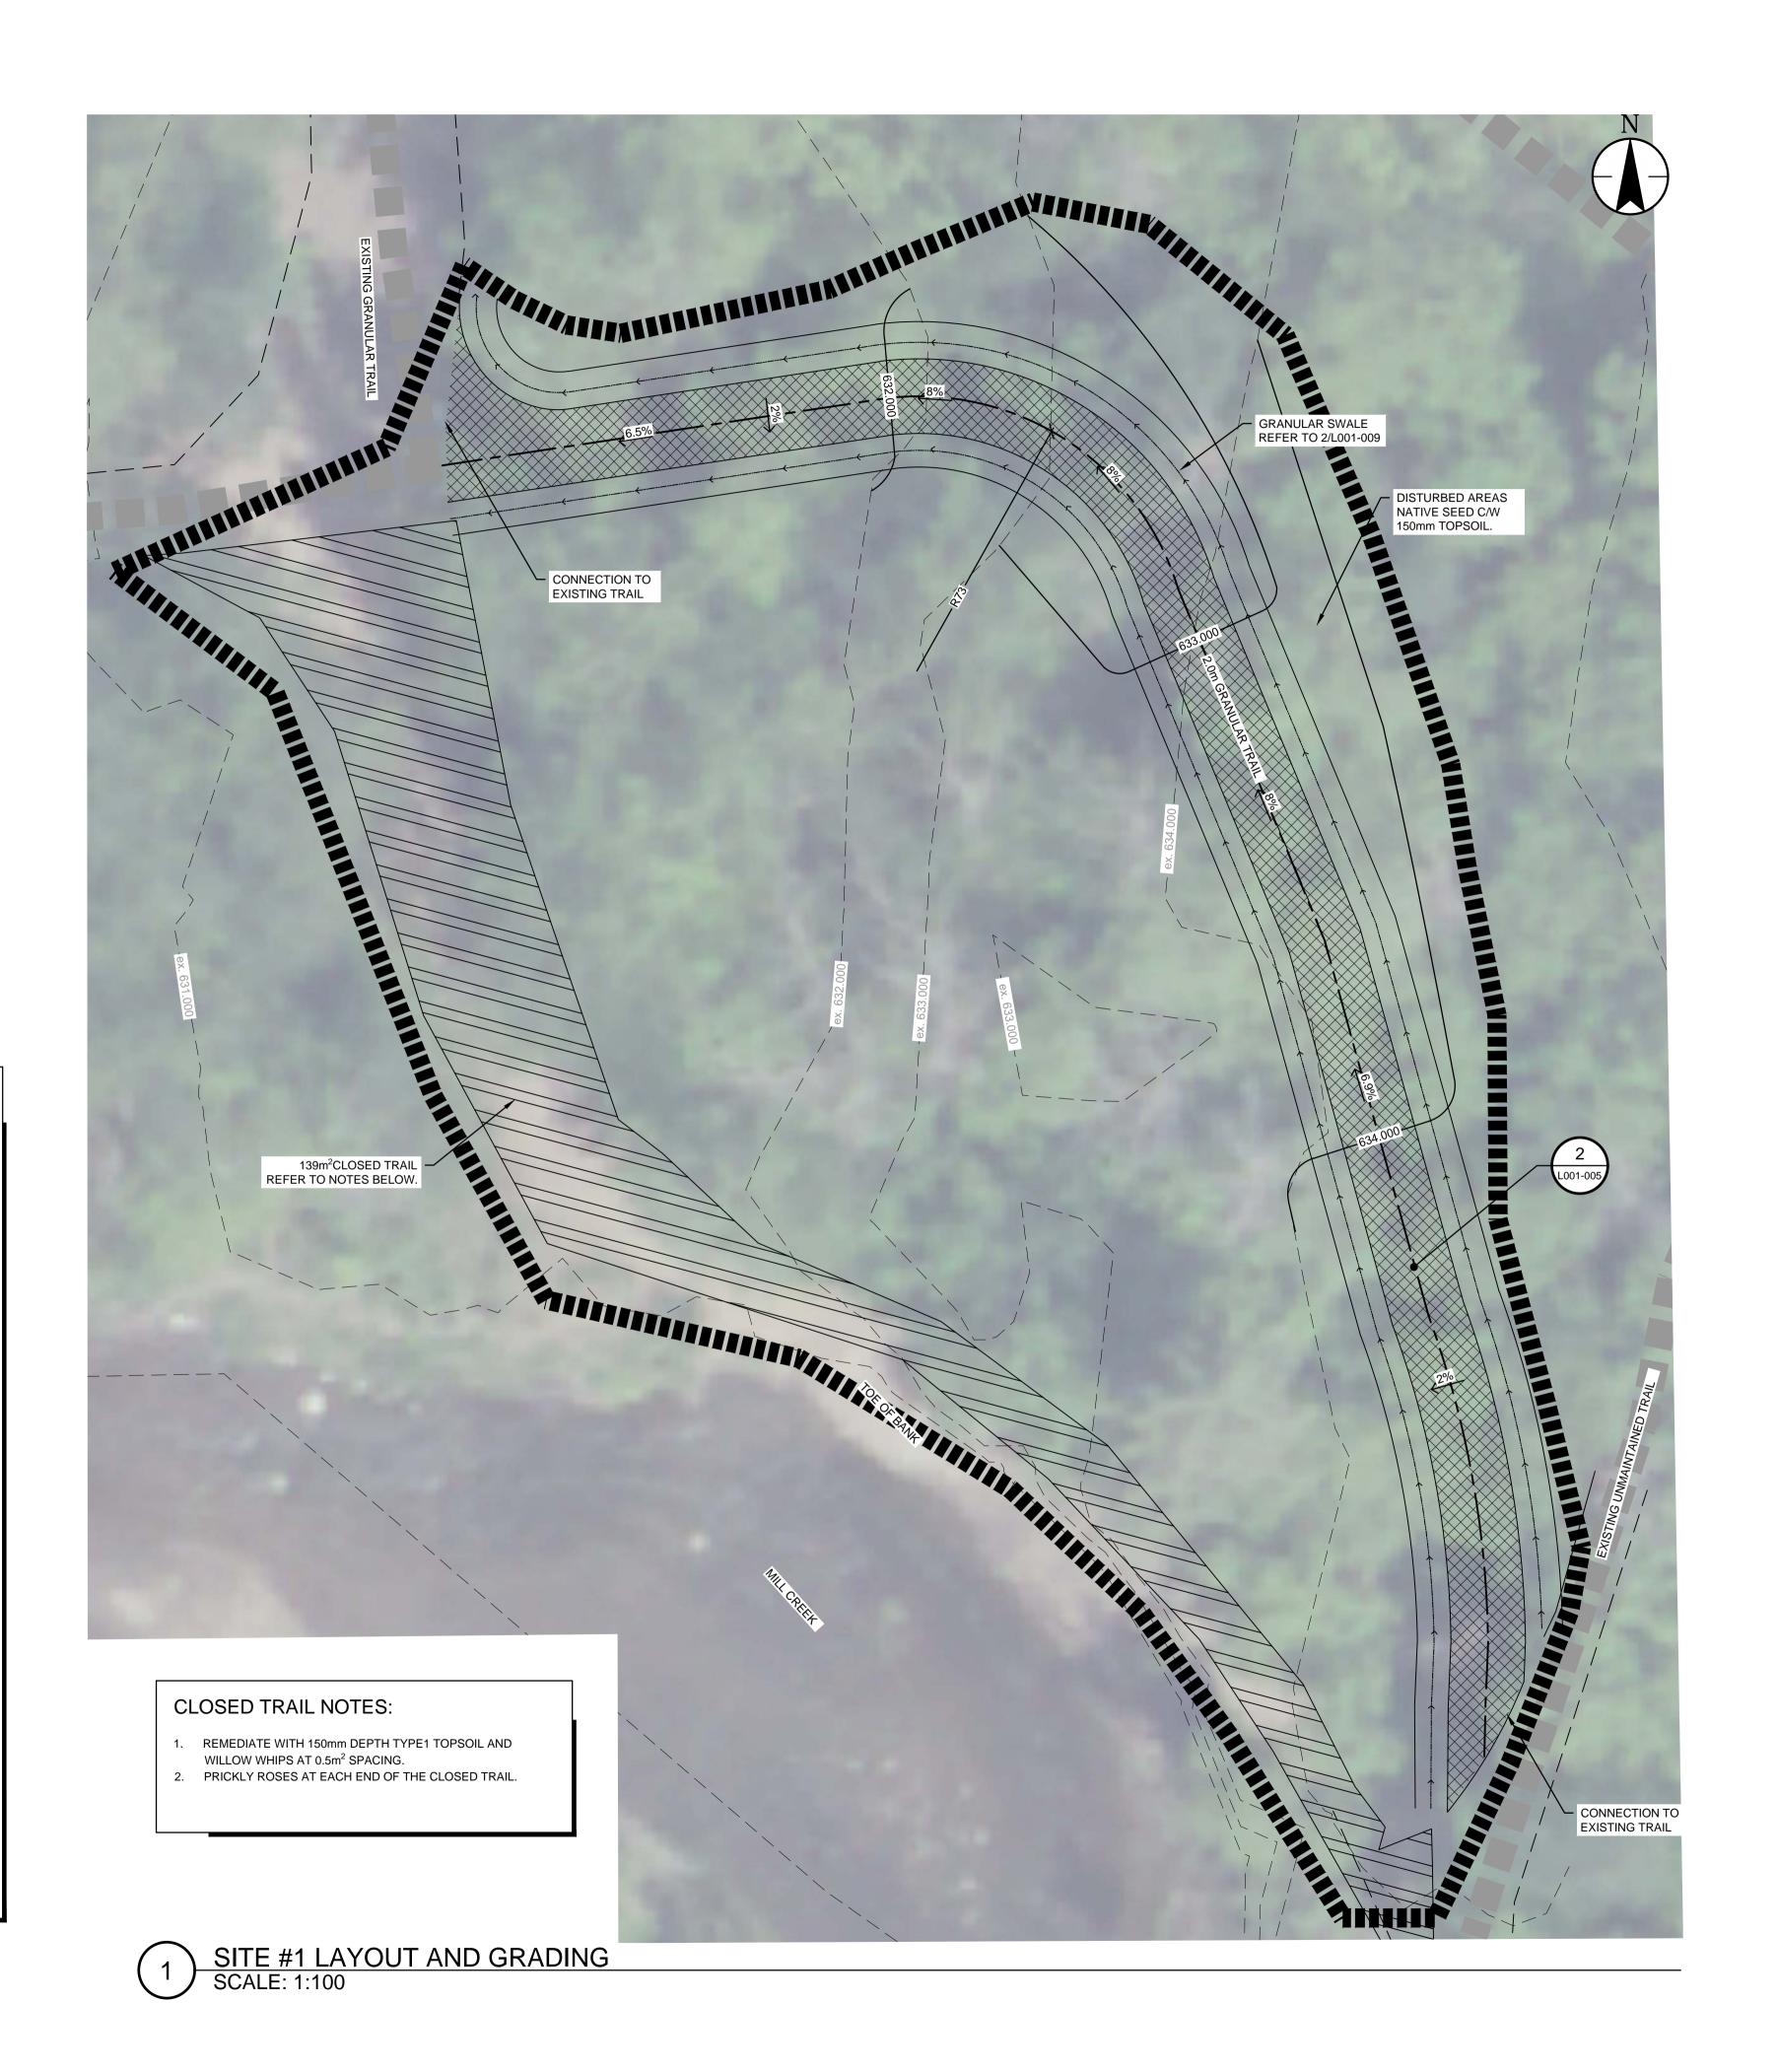



Stantec Consulting Ltd. 10160 - 112 Street Edmonton AB Canada Tel. 780.917.7000

www.stantec.com

Copyright Reserved

The Contractor shall verify and be responsible for all dimensions. DO NOT scale the drawing - any errors or omissions shall be reported to Stantec without delay. The Copyrights to all designs and drawings are the property of Stantec. Reproduction or use for any purpose other than that authorized by Stantec is forbidde

EXISTING GRANULAR TRAIL PROPOSED CONTOUR - - - EXISTING CONTOUR (MAJOR) EXISTING CONTOUR (MINOR) LIMIT OF CONSTRUCTION

DETAIL REFERENCE SYMBOL

UTILITY SETBACKS

LANDSCAPE CONTRACTOR TO CALL 'ALBERTA ONE-CALL' AT I-800-242-3447 TO HAVE ALL EXISTING SITE UTILITIES LOCATED PRIOR TO CONSTRUCTION AND PLANT NO CLOSER THAN THE FOLLOWING DIMENSIONS FROM THE SERVICES:

- 1.0 m FROM POWER LINES 3.5 m FROM ALL POWER HARDWARE
- 1.8 m FROM WATER MAINS, WATER VALVES, MANUAL
- AIRVENTS, AND SERVICES 2.0 m FROM SEWER MAINS, AND MANHOLES
- 1.8 m FROM SEWER SERVICES 1.5 m FROM GAS (NO TREES WITHIN EASEMENT)
- 7.5 m FROM STREET CORNERS.
- 3.5 m FROM FIRE HYDRANTS.
- 1.5 m FROM DRIVEWAYS
- 1.5 m FROM ALLEY ACCESSES
- 1.0 m FROM SIDEWALKS OR AS PER APPROVED ENG. CROSS SECTIONS
- 3.5 m FROM TRANSIT ZONES 3.0 m FROM PRIVATE PROPERTY BOUNDARY
- 1.25 m FROM COLLECTOR ROAD CURB FACE
- 1.25 m FROM LOCAL ROAD CURB FACE
- 2.0 m FROM ARTERIAL ROAD CURB FACE
- 3.5 m FROM YIELD AND STOP SIGNS
- 3.5 m FROM BUS STOP SIGNS
- 19. 2.0 m FROM ALL OTHER SIGNS 20. 1.0 m FROM OTHER UNDERGROUND UTILITIES
- 21. 3.5 m FROM TELUS PEDESTALS 22. 2.0 m FROM TELUS DUCT STRUCTURE
- 23. 1.0 m FROM TELUS CABLE FACILITIES

LANDSCAPE CONTRACTOR IS RESPONSIBLE FOR DAMAGES AND

Development Engineer, Sustainable Developme	ent			
Approvals	_			YY.MM.DD
Revision		Ву	Appd.	YY.MM.DD
1. FIRST SUBMISSION (60%)		DW	NGS	18.05
Issued		Ву	Appd.	YY.MM
File Name: LA_MilCreek.dwg	DW	СВ	NGS	18.03.13
	Dwn.	Chkd.	Dsgn.	YY.MM.DD

Permit-Seal



Client/Project

CITY OF EDMONTON

MILL CREEK RAVINE PARK TRAIL REHABILITATION


Edmonton, Alberta

SITE #1 LAYOUT AND GRADING


Project No. 1161106255 Drawing No. V:\1161\Active\1161106255\drawing_Landscape\LA_MillCreek.dwg 2019-3-18 2:02pm BY: DWIGGLESWORTH 2 of 10

L001-002



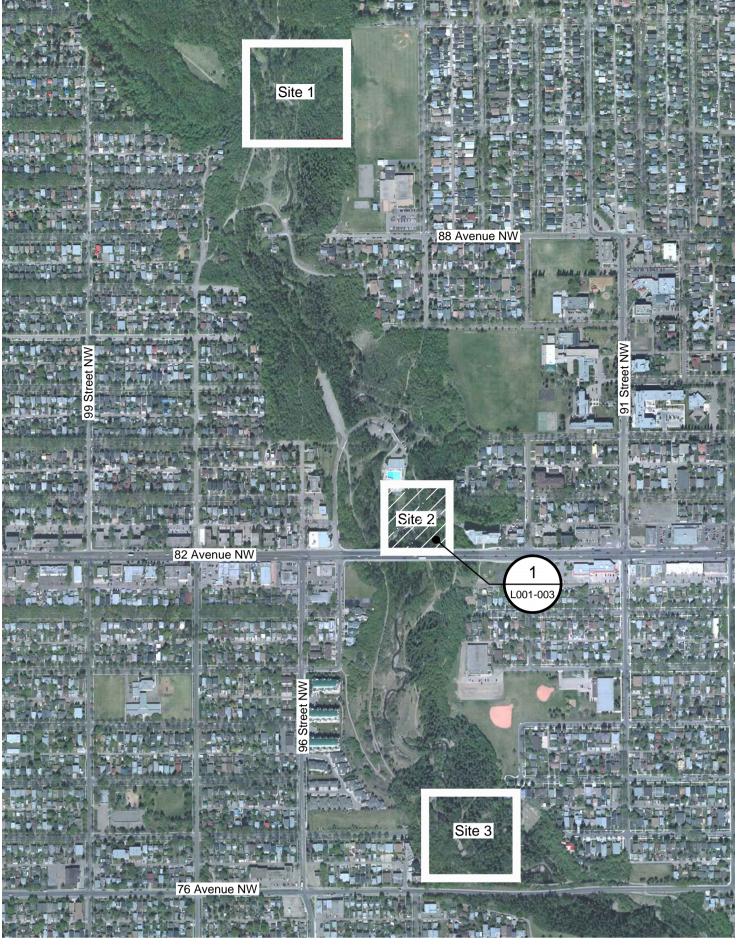

KEY PLAN SCALE: N.T.S.

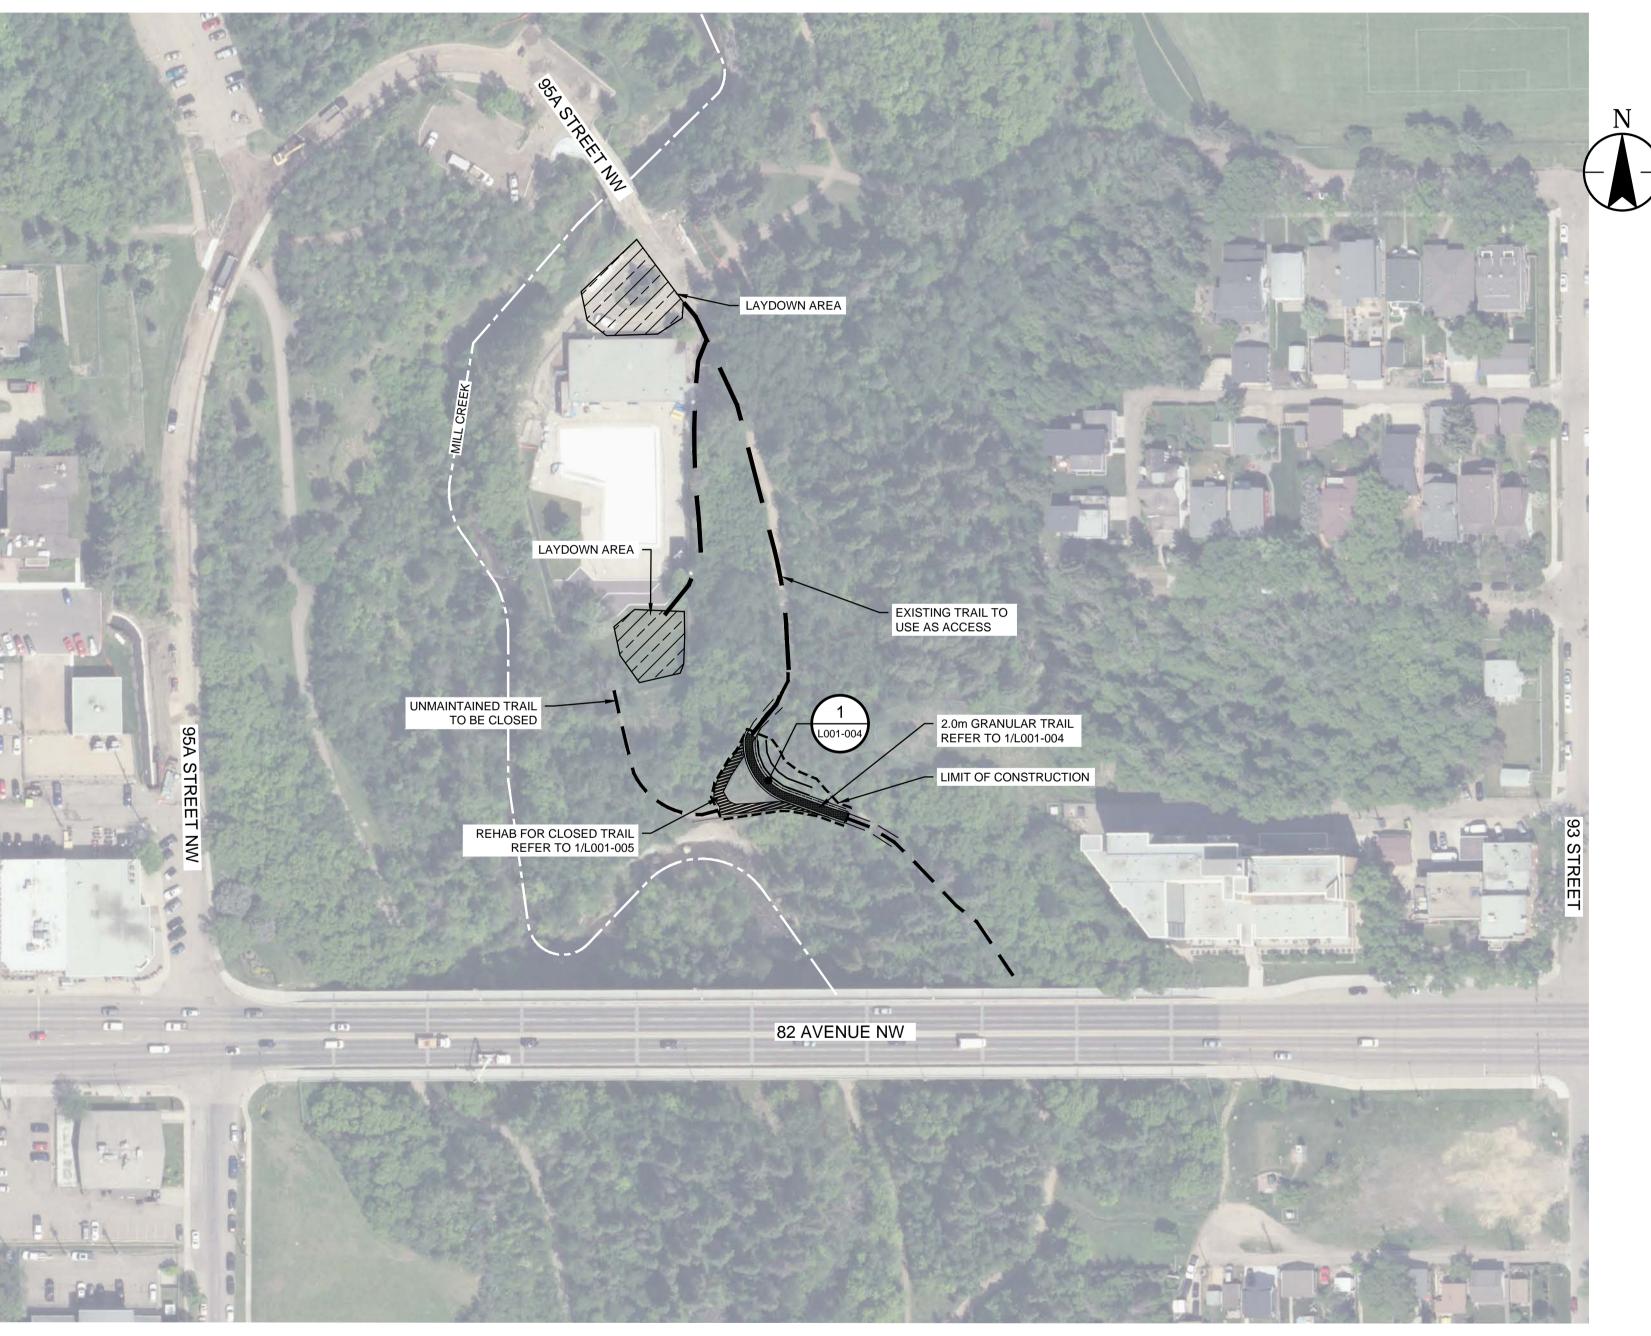

1 SITE #2 OVERALL PLAN
SCALE: 1:1000




Stantec Consulting Ltd. 10160 - 112 Street Edmonton AB Canada Tel. 780.917.7000 www.stantec.com

Copyright Reserved

The Contractor shall verify and be responsible for all dimensions. DO NOT scale the drawing - any errors or omissions shall be reported to Stantec without delay. The Copyrights to all designs and drawings are the property of Stantec. Reproduction or use for any purpose other than that authorized by Stantec is forbidde

Legend

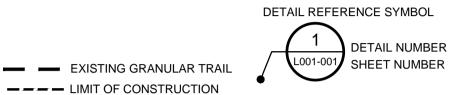

UTILITY SETBACKS

LANDSCAPE CONTRACTOR TO CALL 'ALBERTA ONE-CALL' AT 1-800-242-3447 TO HAVE ALL EXISTING SITE UTILITIES LOCATED PRIOR TO CONSTRUCTION AND PLANT NO CLOSER THAN THE FOLLOWING DIMENSIONS FROM THE SERVICES:

1.0 m FROM POWER LINES 3.5 m FROM ALL POWER HARDWARE

- 3. 1.8 m FROM WATER MAINS, WATER VALVES, MANUAL
- AIRVENTS, AND SERVICES
- 2.0 m FROM SEWER MAINS, AND MANHOLES
- 1.8 m FROM SEWER SERVICES1.5 m FROM GAS (NO TREES WITHIN EASEMENT)
- 7. 7.5 m FROM STREET CORNERS.
- 8. 3.5 m FROM FIRE HYDRANTS.
- 9. 1.5 m FROM DRIVEWAYS
- 1.5 m FROM ALLEY ACCESSES1.0 m FROM SIDEWALKS
- OR AS PER APPROVED ENG. CROSS SECTIONS
- 12. 3.5 m FROM TRANSIT ZONES13. 3.0 m FROM PRIVATE PROPERTY BOUNDARY
- 14. 1.25 m FROM COLLECTOR ROAD CURB FACE
- 15. 1.25 m FROM LOCAL ROAD CURB FACE
- 16. 2.0 m FROM ARTERIAL ROAD CURB FACE
- 17. 3.5 m FROM YIELD AND STOP SIGNS
- 18. 3.5 m FROM BUS STOP SIGNS19. 2.0 m FROM ALL OTHER SIGNS
- 20. 1.0 m FROM OTHER UNDERGROUND UTILITIES21. 3.5 m FROM TELUS PEDESTALS
- 21. 3.5 m FROM TELUS PEDESTALS22. 2.0 m FROM TELUS DUCT STRUCTURE
- 23. 1.0 m FROM TELUS CABLE FACILITIES

LANDSCAPE CONTRACTOR IS RESPONSIBLE FOR DAMAGES AND LIABILITIES INCURRED BY DAMAGES TO SITE UTILITIES.

Development Engineer, Sustainable Dev	гоюринони			· · · · · · · · · · · · · · · · · · ·
Approvals				YY.MM.DD
Revision		Ву	Appd.	YY.MM.DE
		DW	NGS	18.05
1. FIRST SUBMISSION (60%)		DW		10.00
1. FIRST SUBMISSION (60%) ISSUEd		Ву	Appd.	YY.MM
	DW			

Permit-Seal



Client/Project

CITY OF EDMONTON

MILL CREEK RAVINE PARK TRAIL REHABILITATION

Edmonton, Alberta

Title

SITE #2 OVERALL PLAN


Project No. Scale 0 10 20 30 40 50 1:1000 1:1000 Drawing No. 1:1000 Drawing No. 2019-3-18 2:02pm BY: DWIGGLESWORTH 3 of 10 LOO1-003



SCALE: N.T.S.

LAYOUT AND GRADING NOTES:

- CONTRACTOR TO CALL ALBERTA ONE CALL AT 1-800-242-3447 TO HAVE EXISTING UTILITIES LOCATED PRIOR TO START OF ANY CONSTRUCTION.
- THIS DRAWING IS TO BE READ IN CONJUNCTION WITH THE WRITTEN SPECIFICATIONS, DRAWINGS, AND
- DETAILS FOR THE PROJECT. CONTRACTOR TO ENSURE THAT ALL NECESSARY ARRANGEMENTS ARE MADE WITH THE PIPELINE COMPANIES CONCERNING THE MOVEMENT OF MATERIALS AND EQUIPMENT NEAR ANY PIPELINE RIGHTS OF
- 4. CONTRACTOR IS RESPONSIBLE FOR THE HOARDING OF ALL TREES WITHIN OR ADJACENT TO CONSTRUCTION AREAS.
- 5. CONTRACTOR IS RESPONSIBLE FOR THE ADJUSTMENT OF ALL EXISTING CATCHBASINS, CATCHBASIN MANHOLES, MANHOLES, WATER VALVES, HYDRANTS, ETC. TO MATCH PROPOSED GRADES.
- 6. ENSURE POSITIVE DRAINAGE IN ALL SWALES AS SHOWN ON PLAN. DO NOT PERMIT POOLING OF WATER IN DRAINAGE SWALE.
- CONTRACTOR IS RESPONSIBLE FOR HAULING OF ALL EXCESS MATERIALS OFF THE SITE.
- CONTRACTOR IS RESPONSIBLE FOR GENERAL SITE CLEAN UP.
- CONTRACTOR IS RESPONSIBLE FOR ANY DAMAGE TO LANDSCAPED AREAS AND MUST MAKE ALL NECESSARY RESTORATIONS AND REPAIRS.
- 10. ALL ANCILLARY WORK NORMALLY ASSOCIATED WITH THIS TYPE OF CONSTRUCTION SHALL BE DEEMED TO
- BE PART OF THE CONTRACT.
- 11. ALL QUANTITIES ARE APPROXIMATE ONLY.
- 12. GRADES TO BE APPROVED BY LANDSCAPE ARCHITECT PRIOR TO CONSTRUCTION STARTING. 13. CONTRACTOR TO HOLD ROUGH GRADES 450mm BELOW FINISHED GRADE FOR PLANT BEDS, 150mm FOR
- SEEDED AREAS, 200mm FOR WALKS, 100mm FOR SODDED AREAS. 14. STANDARD CONTOUR INTERVAL IS 500mm. SPOT ELEVATIONS AS SHOWN. ALL SPOT ELEVATIONS IN
- METERS. BERMS AND SLOPES TO BE GRADED SMOOTHLY. ELIMINATE ROUGH SPOTS AND LOW AREAS TO ENSURE POSITIVE DRAINAGE PRIOR TO SEEDING. 15. ALL PROPOSED GRADES TO MEET EXISTING GRADES AT PROPERTY LINE WITH A SMOOTH TRANSITION.
- LIMIT OF GRADING NOT TO EXTEND BEYOND PROPERTY LINE. GRADES TO MEET CURB OR WALK SMOOTHLY. LANDSCAPE ARCHITECT TO APPROVE ROUGH AND FINISHED GRADES.
- 16. MAXIMUM SLOPE OF ANY LANDSCAPED AREA NOT TO EXCEED 33%.
- 17. CONTRACTOR TO TAKE NECESSARY PRECAUTIONS TO PROTECT ALL SITE FEATURES EXISTING AT THE TIME OF CONSTRUCTION UNLESS SPECIFIED FOR DEMOLITION ON THE DRAWING. THIS INCLUDES ALL SURVEY BARS, STAKES OR MONUMENTS. MAKE GOOD ANY DAMAGE.
- 18. ANY AMBIGUITY IN THIS DRAWING OR ACCOMPANYING DETAILS IS TO BE REPORTED TO THE LANDSCAPE ARCHITECT FOR DIRECTION. CONTRACTOR NOT TO PROCEED IN UNCERTAINTY. 19. LIMITS OF WORK TO BE CLEARLY UNDERSTOOD BY THE CONTRACTOR PRIOR TO ANY WORK TAKING PLACE
- ON SITE. CONTRACTOR TO CONTACT LANDSCAPE ARCHITECT FOR CLARIFICATION IF REQUIRED. 20. CONTRACTOR TO VISIT SITE TO CONFIRM ALL SITE CONDITIONS PRIOR TO SUBMITTING BIDS.
- DISCREPANCIES TO BE REPORTED TO LANDSCAPE ARCHITECT FOR CLARIFICATION.
- 21. CONTRACTOR TO VERIFY ALL DIMENSIONS AND REPORT ANY DISCREPANCIES TO THE LANDSCAPE
- 22. LAYOUT TO BE APPROVED BY LANDSCAPE ARCHITECT PRIOR TO CONSTRUCTION STARTING. 23. ALL MEASUREMENTS ARE IN METERS UNLESS OTHERWISE NOTED.
- 24. CONTRACTOR SHALL SUPPLY ALL MATERIALS IN QUANTITIES SUFFICIENT TO COMPLETE WORK SHOWN ON THESE DRAWINGS. ANY DISCREPANCIES SHALL BE REPORTED TO THE LANDSCAPE ARCHITECT FOR
- 25. NO SUBSTITUTIONS OF MATERIALS, PRODUCTS OR QUANTITIES WITHOUT PRIOR CONSENT OF LANDSCAPE ARCHITECT.

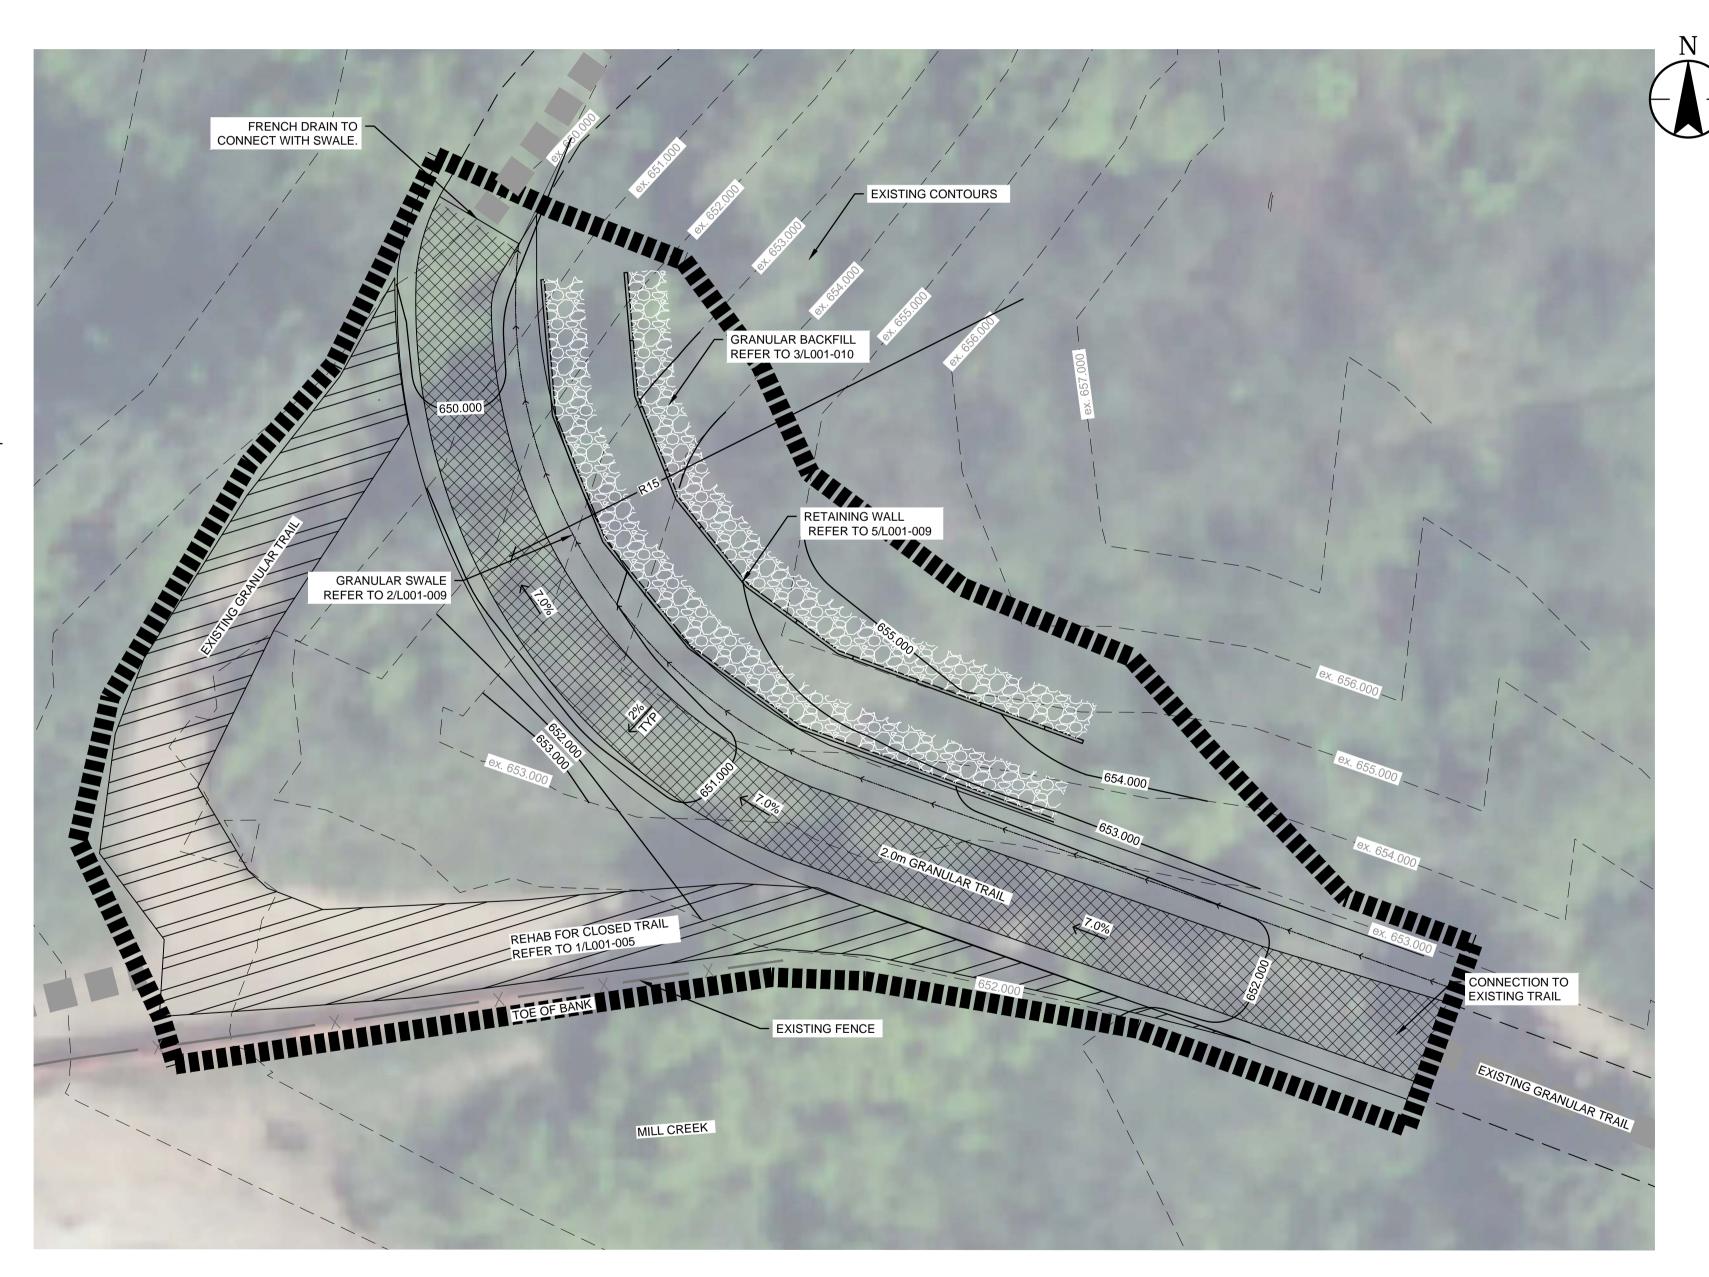





Stantec Consulting Ltd. 10160 - 112 Street Edmonton AB Canada Tel. 780.917.7000

www.stantec.com Copyright Reserved

The Contractor shall verify and be responsible for all dimensions. DO NOT scale the drawing - any errors or omissions shall be reported to Stantec without delay. The Copyrights to all designs and drawings are the property of Stantec. Reproduction or use for any purpose other than that authorized by Stantec is forbidde

DETAIL REFERENCE SYMBOL EXISTING GRANULAR TRAIL PROPOSED CONTOUR - — — EXISTING CONTOUR (MAJOR) LIMIT OF CONSTRUCTION

UTILITY SETBACKS

LANDSCAPE CONTRACTOR TO CALL 'ALBERTA ONE-CALL' AT -800-242-3447 TO HAVE ALL EXISTING SITE UTILITIES LOCATED PRIOR TO CONSTRUCTION AND PLANT NO CLOSER THAN THE FOLLOWING DIMENSIONS FROM THE SERVICES:

- 1.0 m FROM POWER LINES 3.5 m FROM ALL POWER HARDWARE
- 1.8 m FROM WATER MAINS, WATER VALVES, MANUAL
- AIRVENTS, AND SERVICES 2.0 m FROM SEWER MAINS, AND MANHOLES
- 1.8 m FROM SEWER SERVICES 1.5 m FROM GAS (NO TREES WITHIN EASEMENT)
- 7.5 m FROM STREET CORNERS.
- 3.5 m FROM FIRE HYDRANTS.
- 1.5 m FROM DRIVEWAYS
- 1.5 m FROM ALLEY ACCESSES
- 1.0 m FROM SIDEWALKS
- OR AS PER APPROVED ENG. CROSS SECTIONS
- 3.5 m FROM TRANSIT ZONES 3.0 m FROM PRIVATE PROPERTY BOUNDARY
- 1.25 m FROM COLLECTOR ROAD CURB FACE
- 1.25 m FROM LOCAL ROAD CURB FACE 2.0 m FROM ARTERIAL ROAD CURB FACE
- 17. 3.5 m FROM YIELD AND STOP SIGNS
- 18. 3.5 m FROM BUS STOP SIGNS 19. 2.0 m FROM ALL OTHER SIGNS
- 20. 1.0 m FROM OTHER UNDERGROUND UTILITIES 21. 3.5 m FROM TELUS PEDESTALS
- 22. 2.0 m FROM TELUS DUCT STRUCTURE 23. 1.0 m FROM TELUS CABLE FACILITIES

LANDSCAPE CONTRACTOR IS RESPONSIBLE FOR DAMAGES AND

Development Engineer, Sustainable Development Approvals FIRST SUBMISSION (60%) DW NGS Appd. ssued
 DW
 CB
 NGS
 18.03.13

 Dwn.
 Chkd.
 Dsgn.
 YY.MM.DD
 File Name: LA_MillCreek.dwg

Permit-Seal



Client/Project


CITY OF EDMONTON

MILL CREEK RAVINE PARK TRAIL REHABILITATION

Edmonton, Alberta

SITE #2 LAYOUT AND GRADING

Project No. 1161106255 Drawing No. V:\1161\Active\1161106255\drawing_Landscape\LA_MillCreek.dwg L001-004 2019-3-18 2:02pm BY: DWIGGLESWORTH 4 of 10

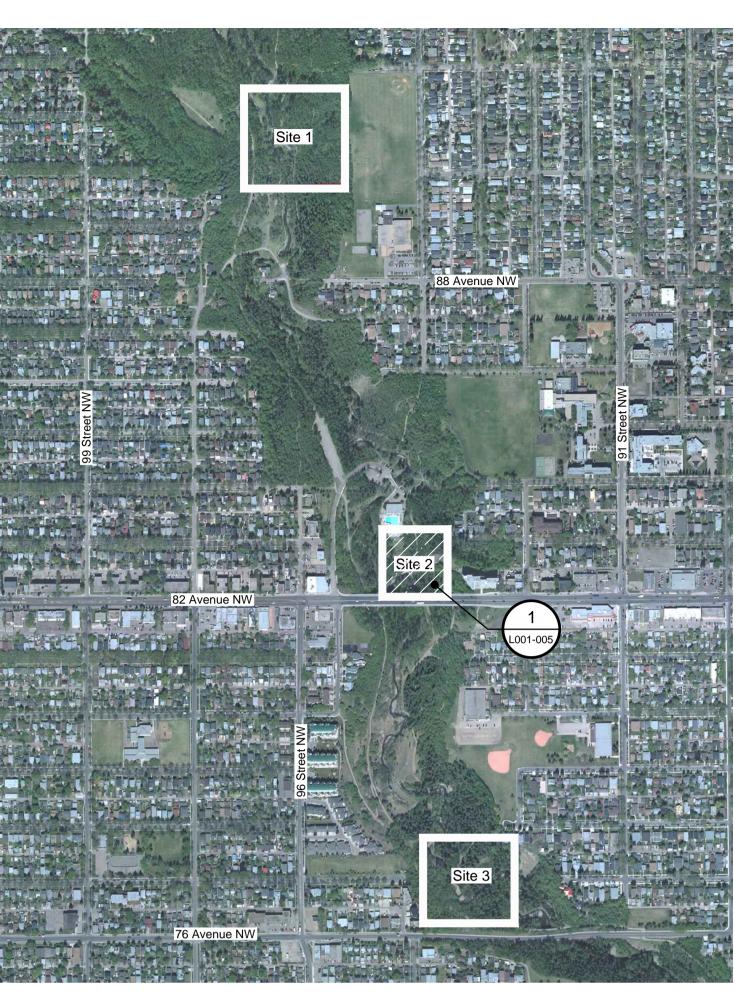

SCALE: N.T.S.

NATIVE SEED MIX

CERTIFIED CANADA NO. 1 MIXTURE, MINIMUM GERMINATION OF 75%, MINIMUM PURITY OF 97%. ALL SEED MUST BE FROM A RECOGNIZED SEED FARM, MEETING THE REQUIREMENTS FOR THE SEEDS ACT FOR CANADA NO. 1 SEED. SEED SHALL BE CERTIFIED NO. 1 GRADE. A GERMINATION TEST MAY BE REQUESTED AND ALL LAWN SEED MUST COMPLY WITH FEDERAL AND PROVINCIAL SEED LAWS.

FOR NON-MAINTAINED NATIVE LANDSCAPING:

- 15% AWNED WHEATGRASS (AGROPYRON TRACHYCAULUM VAR. UNILATERALE) 15% SLENDER WHEATGRASS (AGROPYRON TRACHYCAULUM VAR. TRACHYCAULUM)
- 15% WESTERN WHEAT (AGROPYRON SMITHII) 5% SLOUGHGRASS (BECKMANNIA SYZIGACHNE)
- 5% IDAHO FESCUE (FESTUCA IDAHOENSIS)
- 5% ALKALI BLUEGRASS (POA SECUNDA SSP. JUNCIFOLIA)
- 5% JUNEGRASS (KOELERIA MACRANTHA)
- 5% SANDBERG BLUEGRASS (POA SECUNDA) 20% GREEN NEEDLEGRASS (STRIPA VIRIDULA)
- 10% ROCKY MOUNTAIN FESCUE (FESTUCA SAXIMONTANA)

SEED RATE: 250KG PER HECTARE

PLANTING NOTES:

- CONTRACTOR TO CALL ALBERTA ONE CALL AT 1-800- 242-3447 TO HAVE EXISTING UTILITIES LOCATED PRIOR TO START OF ANY CONSTRUCTION. CONTRACTOR TO ENSURE THAT ALL NECESSARY ARRANGEMENTS ARE MADE WITH THE PIPELINE COMPANIES CONCERNING THE MOVEMENT OF MATERIALS AND
- EQUIPMENT NEAR ANY PIPELINE RIGHTS OF WAY. CONTRACTOR IS RESPONSIBLE FOR THE HOARDING OF ALL TREES WITHIN OR ADJACENT TO CONSTRUCTION AREAS.
- CONTRACTOR IS RESPONSIBLE FOR THE ADJUSTMENT OF ALL EXISTING CATCHBASINS, CATCHBASIN MANHOLES, MANHOLES, WATER VALVES, HYDRANTS, ETC. TO MATCH PROPOSED GRADES.
- 5. CONTRACTOR TO SUPPLY AND INSTALL 12mm FIBRE MASTIC JOINT WHENEVER MATCHING TO OR ABUTTING TO ANY CONCRETE OR BLDG.
- 6. CONTRACTOR IS RESPONSIBLE FOR HAULING OF ALL EXCESS MATERIALS OFF THE
- CONTRACTOR IS RESPONSIBLE FOR GENERAL SITE CLEAN UP. 8. CONTRACTOR IS RESPONSIBLE FOR ANY DAMAGE TO LANDSCAPED AREAS AND
- MUST MAKE ALL NECESSARY RESTORATIONS AND REPAIRS. 9. ALL ANCILLARY WORK NORMALLY ASSOCIATED WITH THIS TYPE OF CONSTRUCTION
- SHALL BE DEEMED TO BE PART OF THE CONTRACT. 10. CONTRACTOR TO VERIFY ALL DIMENSIONS AND REPORT ANY DISCREPANCIES TO
- THE LANDSCAPE ARCHITECT. 11. LAYOUT TO BE APPROVED BY LANDSCAPE ARCHITECT PRIOR TO CONSTRUCTION
- 12. ALL MEASUREMENTS ARE IN METERS UNLESS OTHERWISE NOTED. 13. CONTRACTOR TO OBTAIN APPROVAL FOR PLANT MATERIAL LAYOUT.
- 14. ALL PLANT MATERIAL TO BE NURSERY GROWN STOCK AND SHALL MEET OR EXCEED THE SPECIFICATIONS OF THE CANADIAN NURSERY TRADES ASSOC. FOR SIZE, HEIGHT, SPREAD, GRADING, QUALITY, AND METHOD OF CULTIVATION.
- 15. NO SUBSTITUTIONS OF MATERIALS, PRODUCTS OR QUANTITIES WITHOUT PRIOR
- CONSENT OF LANDSCAPE ARCHITECT. 16. ALL PLANT MATERIAL AND WORKMANSHIP TO CONFORM TO THE REQUIREMENTS OF THE CITY OF EDMONTON DESIGN AND CONSTRUCTION STANDARDS IN ITS MOST
- 17. CONTRACTOR TO CONTACT A CITY OF EDMONTON FORESTRY REPRESENTATIVE A MINIMUM OF FIVE (5) DAYS PRIOR TO THE CONSTRUCTION OF THE CORED BOULEVARDS.

PLANT MATERIAL LIST: (THIS SHEET ONLY)

BOTANICAL/COMMON NAME CONDITION

DECIDUOUS SHRUBS




PRICKLY ROSE

#5 CONTAINER

CONTAINER GROWN, OR BALLED & BURLAPPED 4 CANES OR MORE 400mm HT. WITH MIN ROOT

NOTE: ALL TREES TO BE HIGH HEADED AND EXHIBIT A FULL AND UNIFORM CROWN, WITH A SINGLE, DOMINANT, WELL DEVELOPED LEADER; TREES WITH BROKEN OR DAMAGED OR MISSING LEADERS WILL NOT BE ACCEPTED. ALL PLANT MATERIAL MUST CONFORM TO THE CITY OF EDMONTON DESIGN AND CONSTRUCTION STANDARDS.

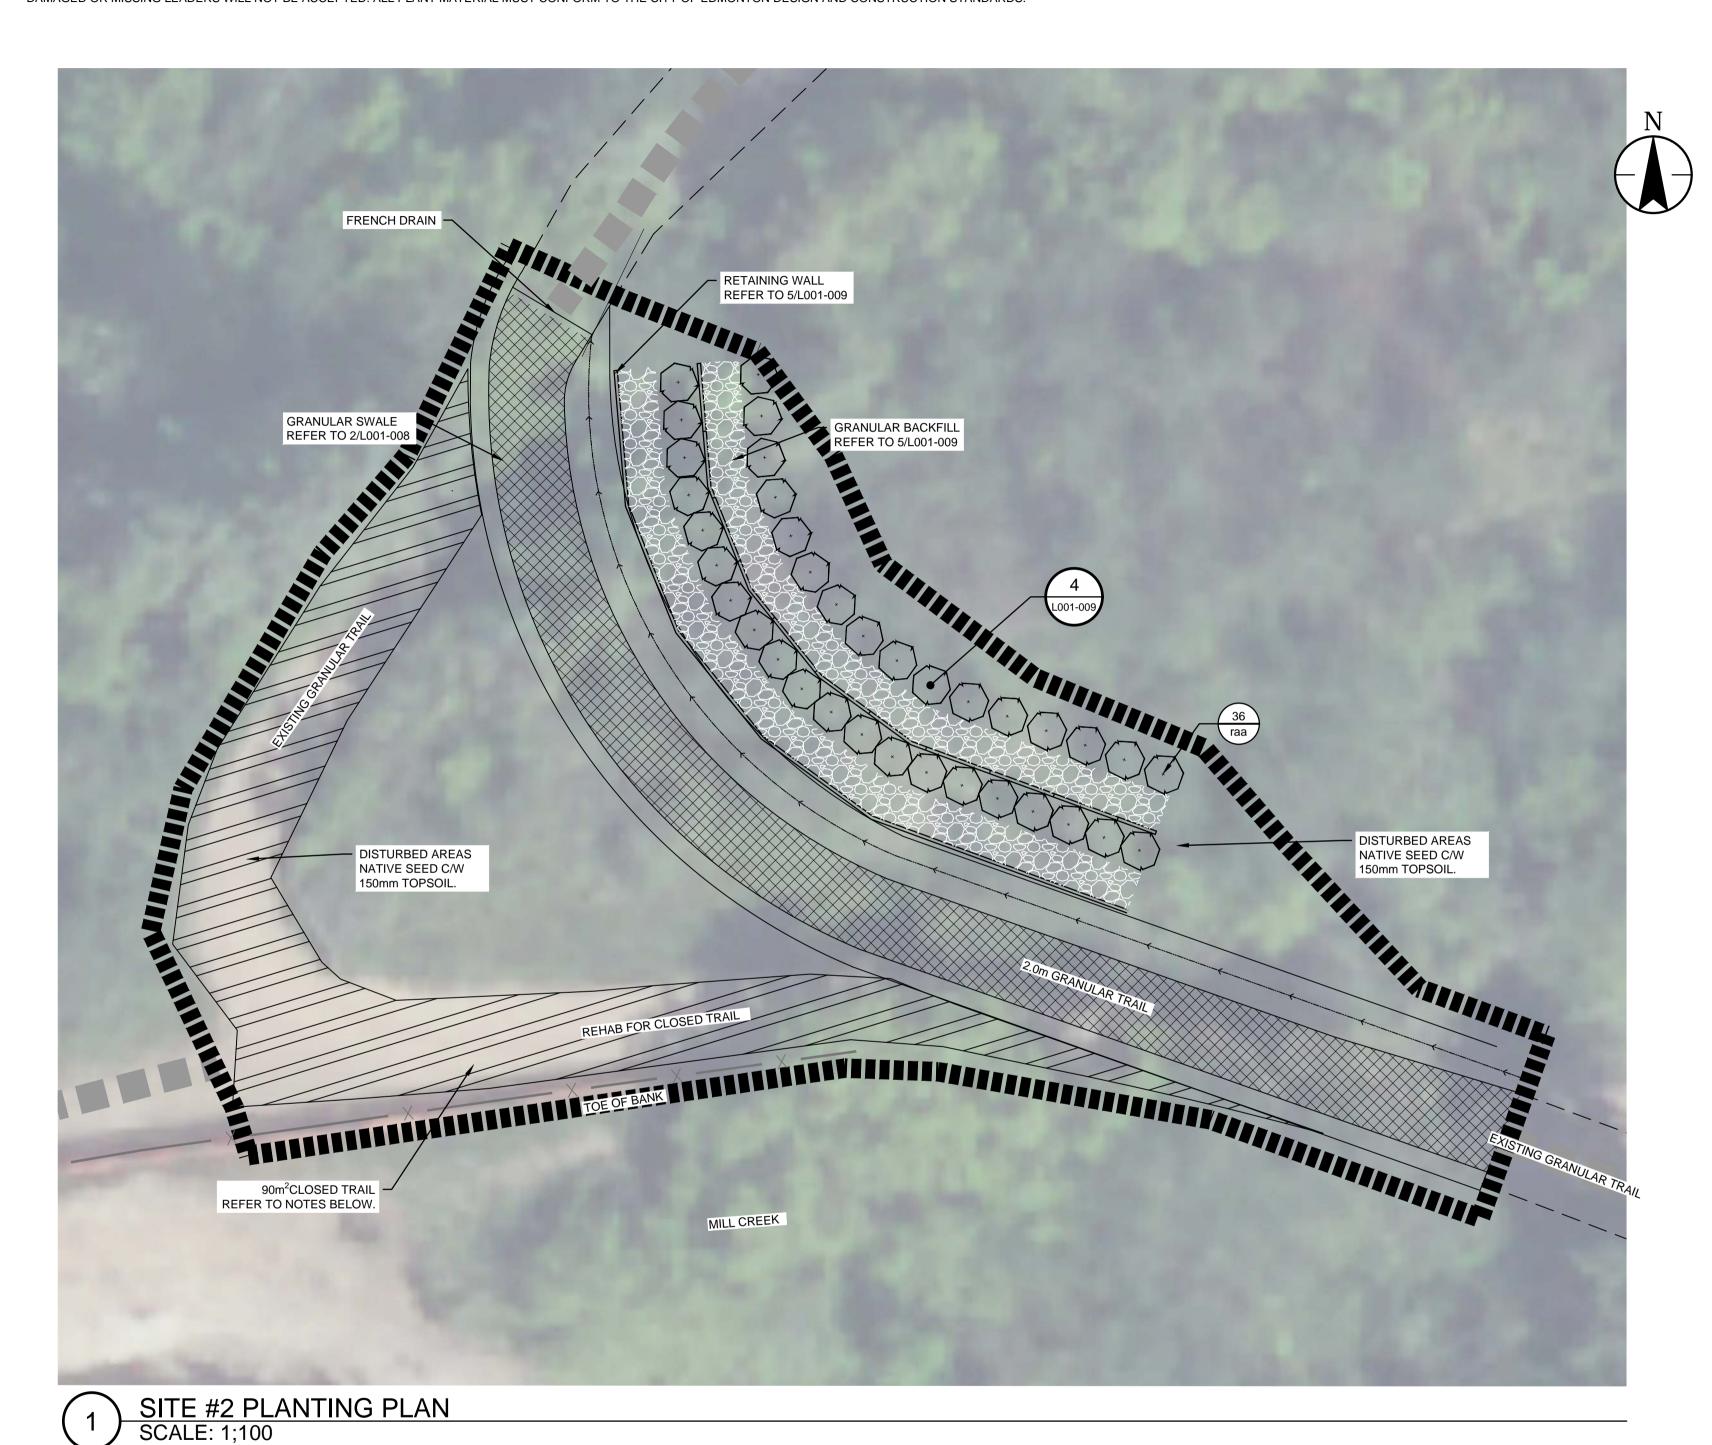

CLOSED TRAIL NOTES:

- 1. REMEDIATE WITH 150mm DEPTH TYPE1 TOPSOIL AND
- WILLOW WHIPS AT 0.5m² SPACING.
- 2. PRICKLY ROSES AT EACH END OF THE CLOSED TRAIL.



Stantec Consulting Ltd. 10160 - 112 Street Edmonton AB Canada Tel. 780.917.7000 www.stantec.com

Copyright Reserved

The Contractor shall verify and be responsible for all dimensions. DO NOT scale the drawing - any errors or omissions shall be reported to Stantec without delay. The Copyrights to all designs and drawings are the property of Stantec. Reproduction or use for any purpose other than that authorized by Stantec is forbidde

5 QUANTITY UAB PLANT SYMBOL DETAIL REFERENCE SYMBOL EXISTING GRANULAR TRAIL

PLANT REFERENCE SYMBOL

LIMIT OF CONSTRUCTION

UTILITY SETBACKS

LANDSCAPE CONTRACTOR TO CALL 'ALBERTA ONE-CALL' AT 1-800-242-3447 TO HAVE ALL EXISTING SITE UTILITIES LOCATED PRIOR TO CONSTRUCTION AND PLANT NO CLOSER THAN THE FOLLOWING DIMENSIONS FROM THE SERVICES:

- 3.5 m FROM ALL POWER HARDWARE
- 1.8 m FROM WATER MAINS, WATER VALVES, MANUAL
- AIRVENTS, AND SERVICES 2.0 m FROM SEWER MAINS, AND MANHOLES
- 1.8 m FROM SEWER SERVICES 1.5 m FROM GAS (NO TREES WITHIN EASEMENT)
- 7.5 m FROM STREET CORNERS.
- 3.5 m FROM FIRE HYDRANTS.
- 1.5 m FROM DRIVEWAYS
- 1.5 m FROM ALLEY ACCESSES
- 1.0 m FROM SIDEWALKS OR AS PER APPROVED ENG. CROSS SECTIONS
- 3.5 m FROM TRANSIT ZONES
- 3.0 m FROM PRIVATE PROPERTY BOUNDARY
- 1.25 m FROM COLLECTOR ROAD CURB FACE 1.25 m FROM LOCAL ROAD CURB FACE
- 3.5 m FROM YIELD AND STOP SIGNS
- 18. 3.5 m FROM BUS STOP SIGNS 19. 2.0 m FROM ALL OTHER SIGNS
- 20. 1.0 m FROM OTHER UNDERGROUND UTILITIES
- 21. 3.5 m FROM TELUS PEDESTALS 22. 2.0 m FROM TELUS DUCT STRUCTURE
- 23. 1.0 m FROM TELUS CABLE FACILITIES

LANDSCAPE CONTRACTOR IS RESPONSIBLE FOR DAMAGES AND

Development Engineer, Sustainable Dev	elopment			
Approvals				YY.MM.DD
Revision		By	Appd.	YY.MM.DD
1. FIRST SUBMISSION (60%)		DW	NGS	18.05
Issued		Ву	Appd.	YY.MM
File Name: LA_MilCreek.dwg	DW	СВ	NGS	18.03.13

Permit-Seal



Client/Project

CITY OF EDMONTON


MILL CREEK RAVINE PARK TRAIL REHABILITATION

Edmonton, Alberta


SITE #2 PLANTING PLAN

Project No. 1161106255 Drawing No. V:\1161\Active\1161106255\drawing_Landscape\LA_MillCreek.dwg L001-005 2019-3-18 2:02pm BY: DWIGGLESWORTH



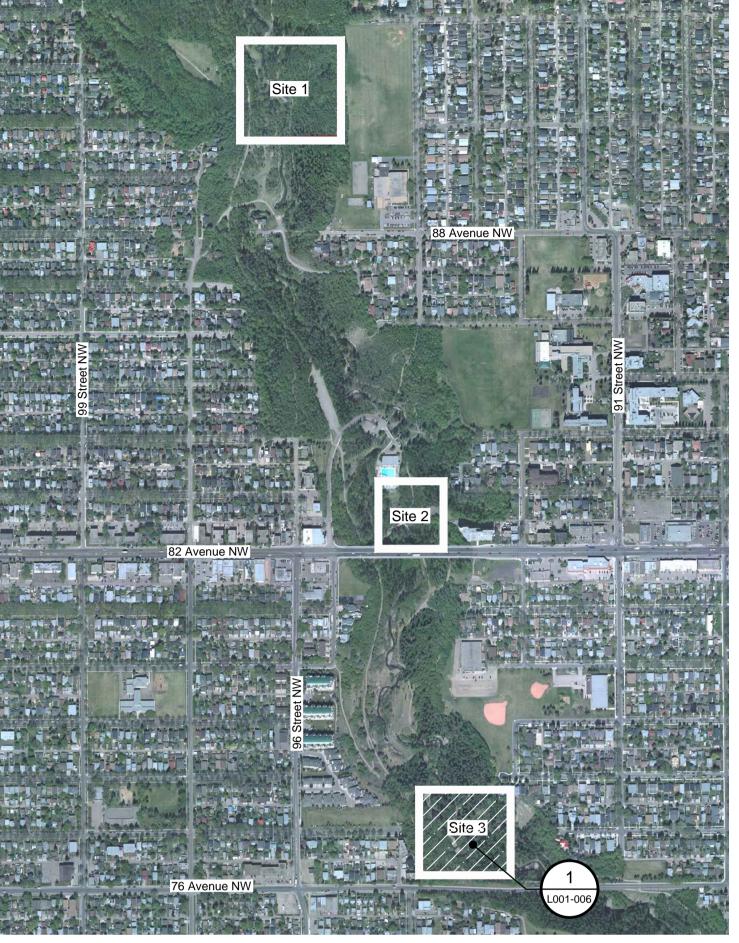

KEY PLAN SCALE: N.T.S.

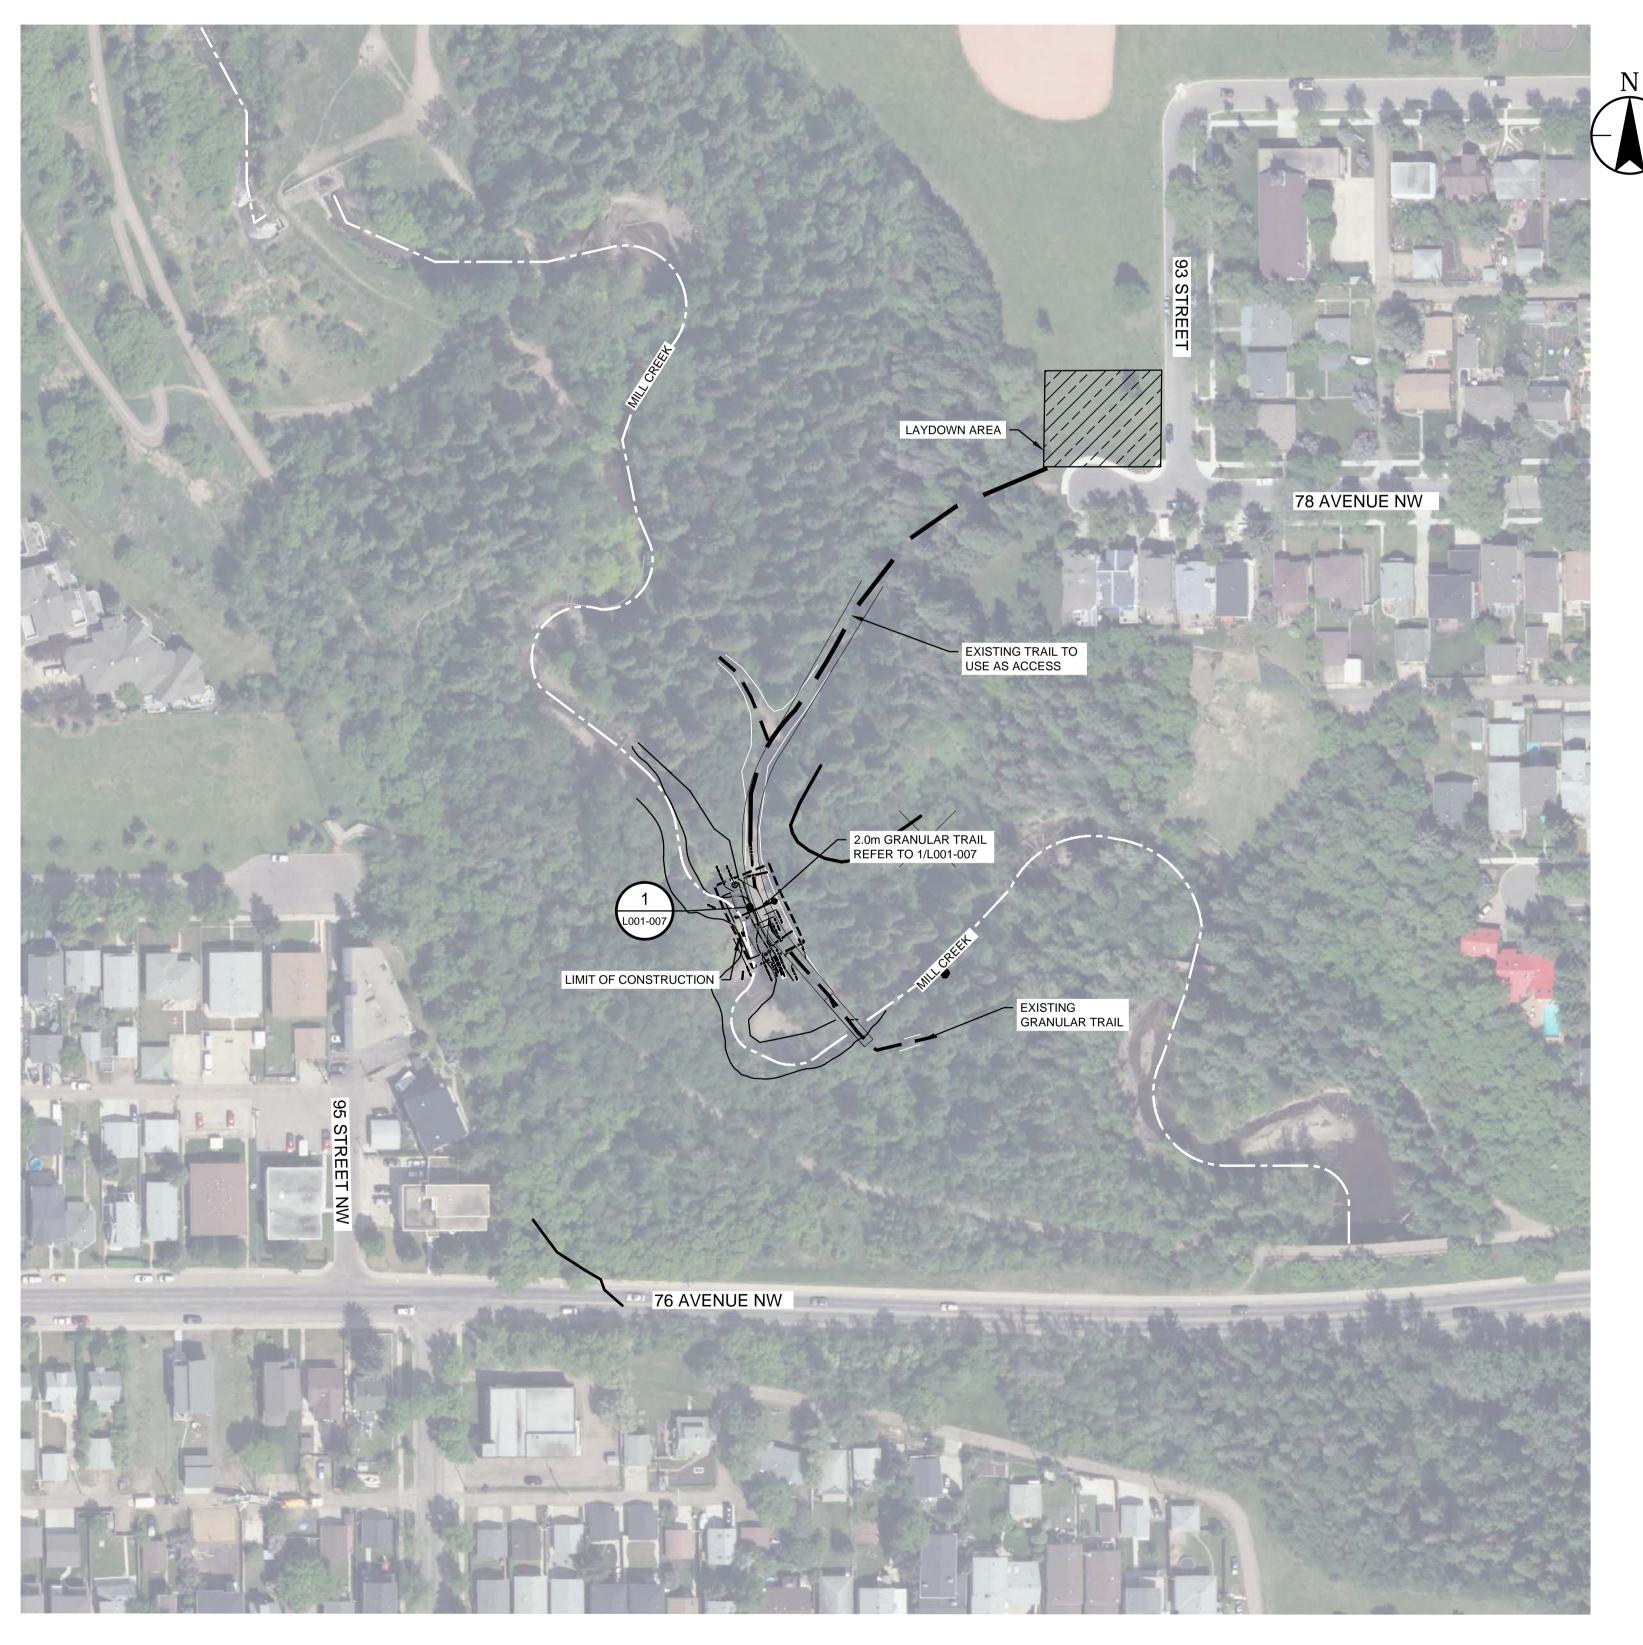






Stantec Consulting Ltd. 10160 - 112 Street Edmonton AB Canada Tel. 780.917.7000

> www.stantec.com Copyright Reserved

The Contractor shall verify and be responsible for all dimensions. DO NOT scale the drawing - any errors or omissions shall be reported to Stantec without delay. The Copyrights to all designs and drawings are the property of Stantec. Reproduction or use for any purpose other than that authorized by Stantec is forbidde

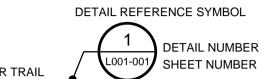

EXISTING GRANULAR TRAIL --- LIMIT OF CONSTRUCTION

UTILITY SETBACKS

LANDSCAPE CONTRACTOR TO CALL 'ALBERTA ONE-CALL' AT 1-800-242-3447 TO HAVE ALL EXISTING SITE UTILITIES LOCATED PRIOR TO CONSTRUCTION AND PLANT NO CLOSER THAN THE FOLLOWING DIMENSIONS FROM THE SERVICES:

1.0 m FROM POWER LINES 3.5 m FROM ALL POWER HARDWARE

- 1.8 m FROM WATER MAINS, WATER VALVES, MANUAL
- AIRVENTS, AND SERVICES
- 2.0 m FROM SEWER MAINS, AND MANHOLES
- 1.8 m FROM SEWER SERVICES 1.5 m FROM GAS (NO TREES WITHIN EASEMENT)
- 7.5 m FROM STREET CORNERS.
- 3.5 m FROM FIRE HYDRANTS.
- 1.5 m FROM DRIVEWAYS
- 1.5 m FROM ALLEY ACCESSES
- 1.0 m FROM SIDEWALKS OR AS PER APPROVED ENG. CROSS SECTIONS
- 12. 3.5 m FROM TRANSIT ZONES
- 13. 3.0 m FROM PRIVATE PROPERTY BOUNDARY
- 14. 1.25 m FROM COLLECTOR ROAD CURB FACE
- 1.25 m FROM LOCAL ROAD CURB FACE 16. 2.0 m FROM ARTERIAL ROAD CURB FACE
- 17. 3.5 m FROM YIELD AND STOP SIGNS
- 18. 3.5 m FROM BUS STOP SIGNS
- 19. 2.0 m FROM ALL OTHER SIGNS20. 1.0 m FROM OTHER UNDERGROUND UTILITIES
- 21. 3.5 m FROM TELUS PEDESTALS 22. 2.0 m FROM TELUS DUCT STRUCTURE
- 23. 1.0 m FROM TELUS CABLE FACILITIES

LANDSCAPE CONTRACTOR IS RESPONSIBLE FOR DAMAGES AND

Development Engineer, Sustainable Dev	velopment			
Approvals				YY.MM.DE
Revision		Ву	Appd.	YY.MM.D[
1. FIRST SUBMISSION (60%)		DW	NGS	18.05
Issued		Ву	Appd.	YY.MM
File Name: LA_MilCreek.dwg	DW	СВ	NGS	18.03.13



Client/Project

CITY OF EDMONTON

MILL CREEK RAVINE PARK TRAIL REHABILITATION

Edmonton, Alberta

SITE #3 OVERALL PLAN

1161106255 Drawing No. V:\1161\Active\1161106255\drawing_Landscape\LA_M**ill**Creek.dwg L001-006 2019-3-18 2:02pm BY: DWIGGLESWORTH 6 of 10



KEY PLAN SCALE: N.T.S.


LAYOUT AND GRADING NOTES:


- 1. CONTRACTOR TO CALL ALBERTA ONE CALL AT 1-800-242-3447 TO HAVE EXISTING UTILITIES LOCATED PRIOR TO START OF ANY CONSTRUCTION.
- 2. THIS DRAWING IS TO BE READ IN CONJUNCTION WITH THE WRITTEN SPECIFICATIONS, DRAWINGS, AND DETAILS FOR THE PROJECT.
- CONTRACTOR TO ENSURE THAT ALL NECESSARY ARRANGEMENTS ARE MADE WITH THE PIPELINE COMPANIES CONCERNING THE MOVEMENT OF MATERIALS AND EQUIPMENT NEAR ANY PIPELINE RIGHTS OF
- 4. CONTRACTOR IS RESPONSIBLE FOR THE HOARDING OF ALL TREES WITHIN OR ADJACENT TO
- CONSTRUCTION AREAS. CONTRACTOR IS RESPONSIBLE FOR THE ADJUSTMENT OF ALL EXISTING CATCHBASINS, CATCHBASIN
- MANHOLES, MANHOLES, WATER VALVES, HYDRANTS, ETC. TO MATCH PROPOSED GRADES. 6. ENSURE POSITIVE DRAINAGE IN ALL SWALES AS SHOWN ON PLAN. DO NOT PERMIT POOLING OF WATER IN
- CONTRACTOR IS RESPONSIBLE FOR HAULING OF ALL EXCESS MATERIALS OFF THE SITE. CONTRACTOR IS RESPONSIBLE FOR GENERAL SITE CLEAN UP.
- 9. CONTRACTOR IS RESPONSIBLE FOR ANY DAMAGE TO LANDSCAPED AREAS AND MUST MAKE ALL
- NECESSARY RESTORATIONS AND REPAIRS.
- 10. ALL ANCILLARY WORK NORMALLY ASSOCIATED WITH THIS TYPE OF CONSTRUCTION SHALL BE DEEMED TO BE PART OF THE CONTRACT.
- 11. ALL QUANTITIES ARE APPROXIMATE ONLY.

DRAINAGE SWALE.

- 12. GRADES TO BE APPROVED BY LANDSCAPE ARCHITECT PRIOR TO CONSTRUCTION STARTING. 13. CONTRACTOR TO HOLD ROUGH GRADES 450mm BELOW FINISHED GRADE FOR PLANT BEDS, 150mm FOR
- SEEDED AREAS, 200mm FOR WALKS, 100mm FOR SODDED AREAS. 14. STANDARD CONTOUR INTERVAL IS 500mm. SPOT ELEVATIONS AS SHOWN. ALL SPOT ELEVATIONS IN
- METERS. BERMS AND SLOPES TO BE GRADED SMOOTHLY. ELIMINATE ROUGH SPOTS AND LOW AREAS TO ENSURE POSITIVE DRAINAGE PRIOR TO SEEDING.
- 15. ALL PROPOSED GRADES TO MEET EXISTING GRADES AT PROPERTY LINE WITH A SMOOTH TRANSITION. LIMIT OF GRADING NOT TO EXTEND BEYOND PROPERTY LINE. GRADES TO MEET CURB OR WALK SMOOTHLY. LANDSCAPE ARCHITECT TO APPROVE ROUGH AND FINISHED GRADES.
- 16. MAXIMUM SLOPE OF ANY LANDSCAPED AREA NOT TO EXCEED 33%.
- 17. CONTRACTOR TO TAKE NECESSARY PRECAUTIONS TO PROTECT ALL SITE FEATURES EXISTING AT THE TIME OF CONSTRUCTION UNLESS SPECIFIED FOR DEMOLITION ON THE DRAWING. THIS INCLUDES ALL SURVEY BARS, STAKES OR MONUMENTS. MAKE GOOD ANY DAMAGE.
- 18. ANY AMBIGUITY IN THIS DRAWING OR ACCOMPANYING DETAILS IS TO BE REPORTED TO THE LANDSCAPE ARCHITECT FOR DIRECTION. CONTRACTOR NOT TO PROCEED IN UNCERTAINTY.
- 19. LIMITS OF WORK TO BE CLEARLY UNDERSTOOD BY THE CONTRACTOR PRIOR TO ANY WORK TAKING PLACE
- ON SITE. CONTRACTOR TO CONTACT LANDSCAPE ARCHITECT FOR CLARIFICATION IF REQUIRED. 20. CONTRACTOR TO VISIT SITE TO CONFIRM ALL SITE CONDITIONS PRIOR TO SUBMITTING BIDS.
- DISCREPANCIES TO BE REPORTED TO LANDSCAPE ARCHITECT FOR CLARIFICATION.
- 21. CONTRACTOR TO VERIFY ALL DIMENSIONS AND REPORT ANY DISCREPANCIES TO THE LANDSCAPE
- ARCHITECT. 22. LAYOUT TO BE APPROVED BY LANDSCAPE ARCHITECT PRIOR TO CONSTRUCTION STARTING.
- 23. ALL MEASUREMENTS ARE IN METERS UNLESS OTHERWISE NOTED.
- 24. CONTRACTOR SHALL SUPPLY ALL MATERIALS IN QUANTITIES SUFFICIENT TO COMPLETE WORK SHOWN ON THESE DRAWINGS. ANY DISCREPANCIES SHALL BE REPORTED TO THE LANDSCAPE ARCHITECT FOR
- 25. NO SUBSTITUTIONS OF MATERIALS, PRODUCTS OR QUANTITIES WITHOUT PRIOR CONSENT OF LANDSCAPE ARCHITECT.



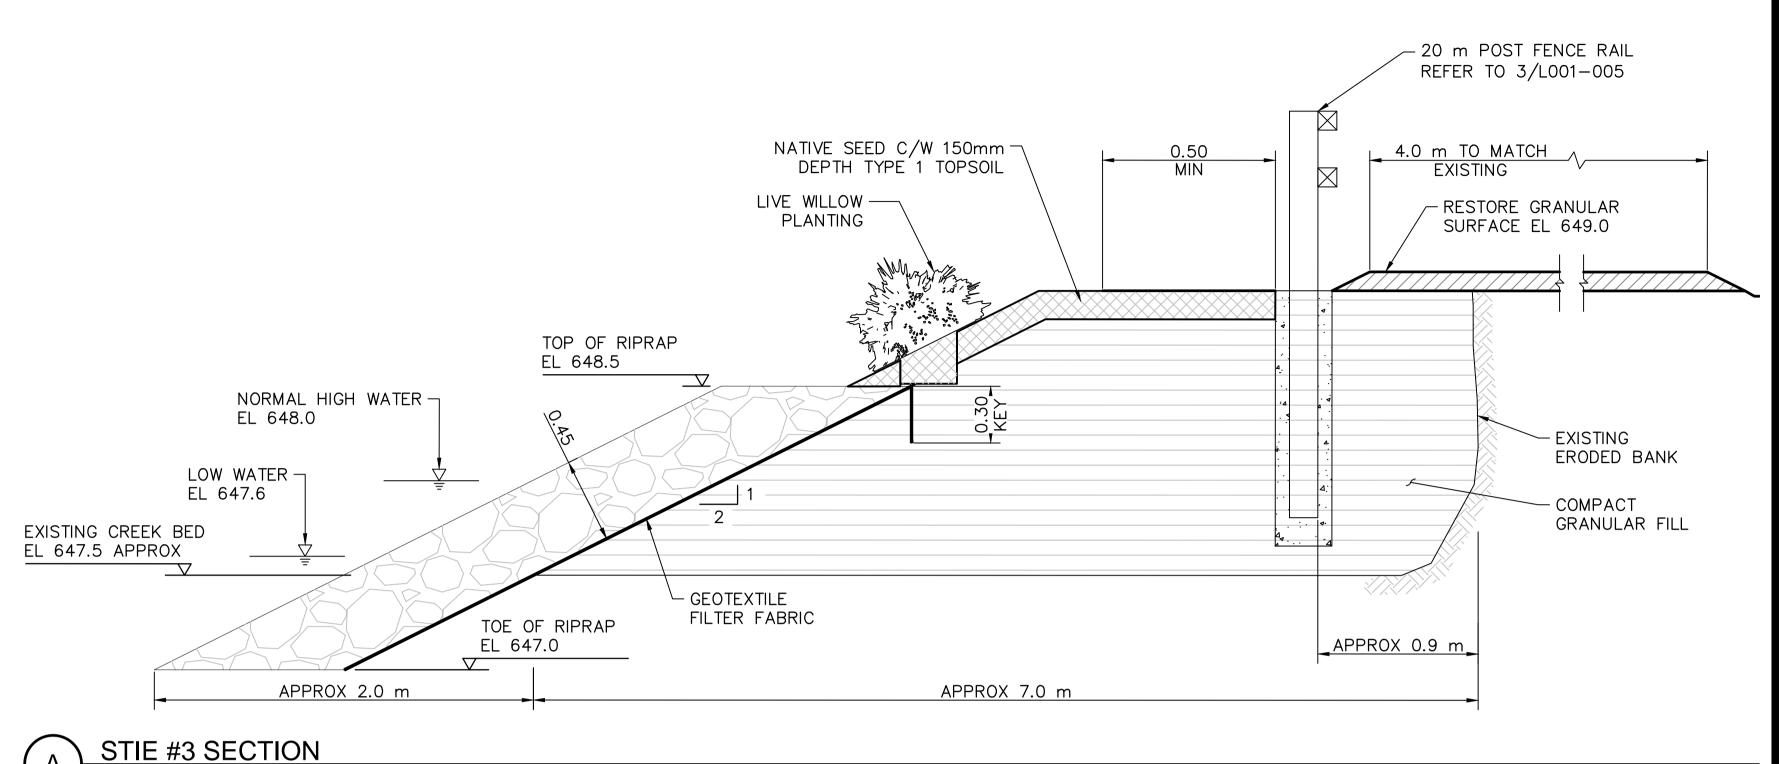

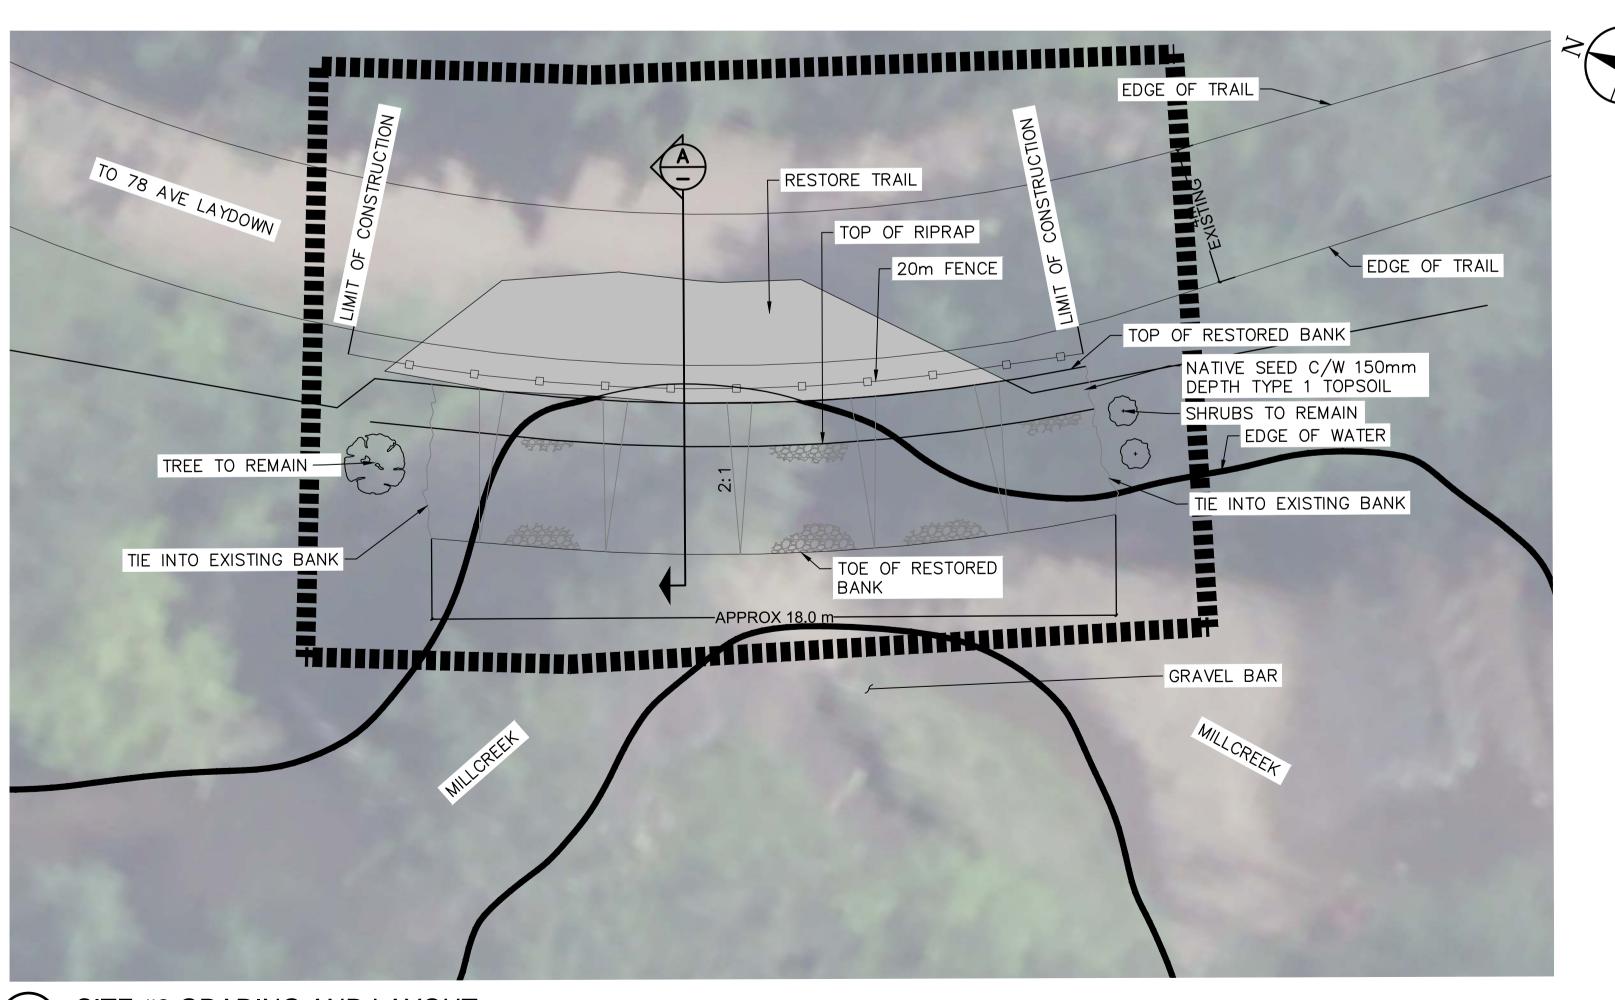

SITE #3 GRADING AND LAYOUT SCALE: 1:100


SCALE: 1:20

10160 - 112 Street Edmonton AB Canada Tel. 780.917.7000

> www.stantec.com Copyright Reserved

Stantec Consulting Ltd.

The Contractor shall verify and be responsible for all dimensions. DO NOT scale the drawing - any errors or omissions shall be reported to Stantec without delay. The Copyrights to all designs and drawings are the property of Stantec. Reproduction or use for any purpose other than that authorized by Stantec is forbidde

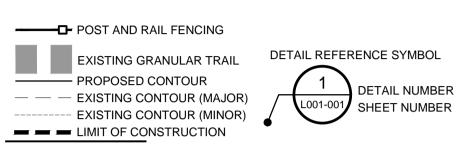

UTILITY SETBACKS

LANDSCAPE CONTRACTOR TO CALL 'ALBERTA ONE-CALL' AT -800-242-3447 TO HAVE ALL EXISTING SITE UTILITIES LOCATED PRIOR TO CONSTRUCTION AND PLANT NO CLOSER THAN THE FOLLOWING DIMENSIONS FROM THE SERVICES:

- 1.0 m FROM POWER LINES 3.5 m FROM ALL POWER HARDWARE
- 1.8 m FROM WATER MAINS, WATER VALVES, MANUAL
- AIRVENTS, AND SERVICES 2.0 m FROM SEWER MAINS, AND MANHOLES
- 1.8 m FROM SEWER SERVICES 1.5 m FROM GAS (NO TREES WITHIN EASEMENT)
- 7.5 m FROM STREET CORNERS.
- 3.5 m FROM FIRE HYDRANTS.
- 1.5 m FROM DRIVEWAYS
- 1.5 m FROM ALLEY ACCESSES
- 1.0 m FROM SIDEWALKS
- OR AS PER APPROVED ENG. CROSS SECTIONS
- 3.5 m FROM TRANSIT ZONES 3.0 m FROM PRIVATE PROPERTY BOUNDARY
- 1.25 m FROM COLLECTOR ROAD CURB FACE
- 1.25 m FROM LOCAL ROAD CURB FACE 2.0 m FROM ARTERIAL ROAD CURB FACE
- 3.5 m FROM YIELD AND STOP SIGNS
- 18. 3.5 m FROM BUS STOP SIGNS
- 19. 2.0 m FROM ALL OTHER SIGNS 20. 1.0 m FROM OTHER UNDERGROUND UTILITIES
- 21. 3.5 m FROM TELUS PEDESTALS 22. 2.0 m FROM TELUS DUCT STRUCTURE
- 23. 1.0 m FROM TELUS CABLE FACILITIES

LANDSCAPE CONTRACTOR IS RESPONSIBLE FOR DAMAGES AND

Development Engineer, Sustainable Developm	nent			
Approvals				YY.MM.DD
Revision		Ву	Appd.	YY.MM.DD
1. FIRST SUBMISSION (60%)				18.05
1. FIRST SUBMISSION (60%) ISSUEd		DW By	NGS Appd.	18.05 YY.MM
	DW			

rermii-seai



Client/Project


CITY OF EDMONTON

MILL CREEK RAVINE PARK TRAIL REHABILITATION

Edmonton, Alberta

SITE #3 GRADING AND LAYOUT

Project No. 1161106255 Drawing No. V:\1161\Active\1161106255\drawing_Landscape\LA_MillCreek.dwg L001-007 2019-3-18 2:02pm BY: DWIGGLESWORTH

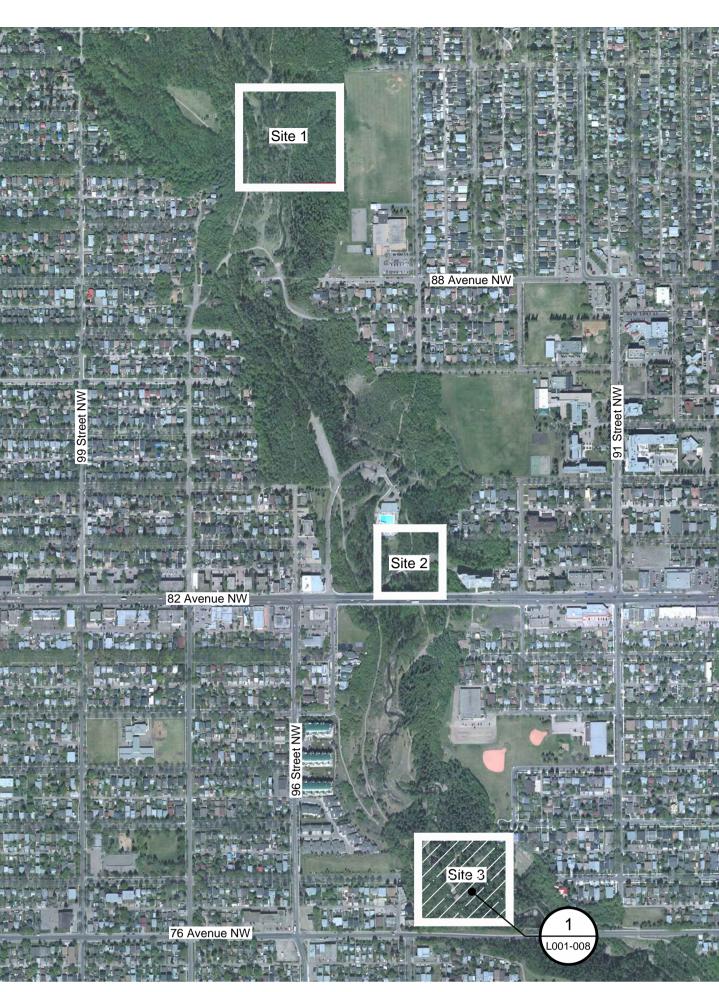

SCALE: N.T.S.

NATIVE SEED MIX

CERTIFIED CANADA NO. 1 MIXTURE, MINIMUM GERMINATION OF 75%, MINIMUM PURITY OF 97%. ALL SEED MUST BE FROM A RECOGNIZED SEED FARM, MEETING THE REQUIREMENTS FOR THE SEEDS ACT FOR CANADA NO. 1 SEED. SEED SHALL BE CERTIFIED NO. 1 GRADE. A GERMINATION TEST MAY BE REQUESTED AND ALL LAWN SEED MUST COMPLY WITH FEDERAL AND PROVINCIAL SEED LAWS.

FOR NON-MAINTAINED NATIVE LANDSCAPING:

- 15% AWNED WHEATGRASS (AGROPYRON TRACHYCAULUM VAR. UNILATERALE)
- 15% SLENDER WHEATGRASS (AGROPYRON TRACHYCAULUM VAR. TRACHYCAULUM) 15% WESTERN WHEAT (AGROPYRON SMITHII)
- 5% SLOUGHGRASS (BECKMANNIA SYZIGACHNE) 5% IDAHO FESCUE (FESTUCA IDAHOENSIS)
- 5% ALKALI BLUEGRASS (POA SECUNDA SSP. JUNCIFOLIA)
- 5% JUNEGRASS (KOELERIA MACRANTHA)
- 5% SANDBERG BLUEGRASS (POA SECUNDA)
- 20% GREEN NEEDLEGRASS (STRIPA VIRIDULA)
- 10% ROCKY MOUNTAIN FESCUE (FESTUCA SAXIMONTANA)

SEED RATE: 250KG PER HECTARE

PLANT MATERIAL LIST: (THIS SHEET ONLY)

QTY./SYM. BOTANICAL/COMMON NAME CONDITION


DECIDUOUS SHRUBS

Salix brachycarpa 'Blue fox' **BLUE FOX WILLOW**

450 mm HT. MIN. #5 CONTAINER

CONTAINER GROWN, OR BALLED & BURLAPPED 4 CANES OR MORE 400mm HT. WITH MIN ROOT

NOTE: ALL TREES TO BE HIGH HEADED AND EXHIBIT A FULL AND UNIFORM CROWN, WITH A SINGLE, DOMINANT, WELL DEVELOPED LEADER; TREES WITH BROKEN OR DAMAGED OR MISSING LEADERS WILL NOT BE ACCEPTED. ALL PLANT MATERIAL MUST CONFORM TO THE CITY OF EDMONTON DESIGN AND CONSTRUCTION STANDARDS.

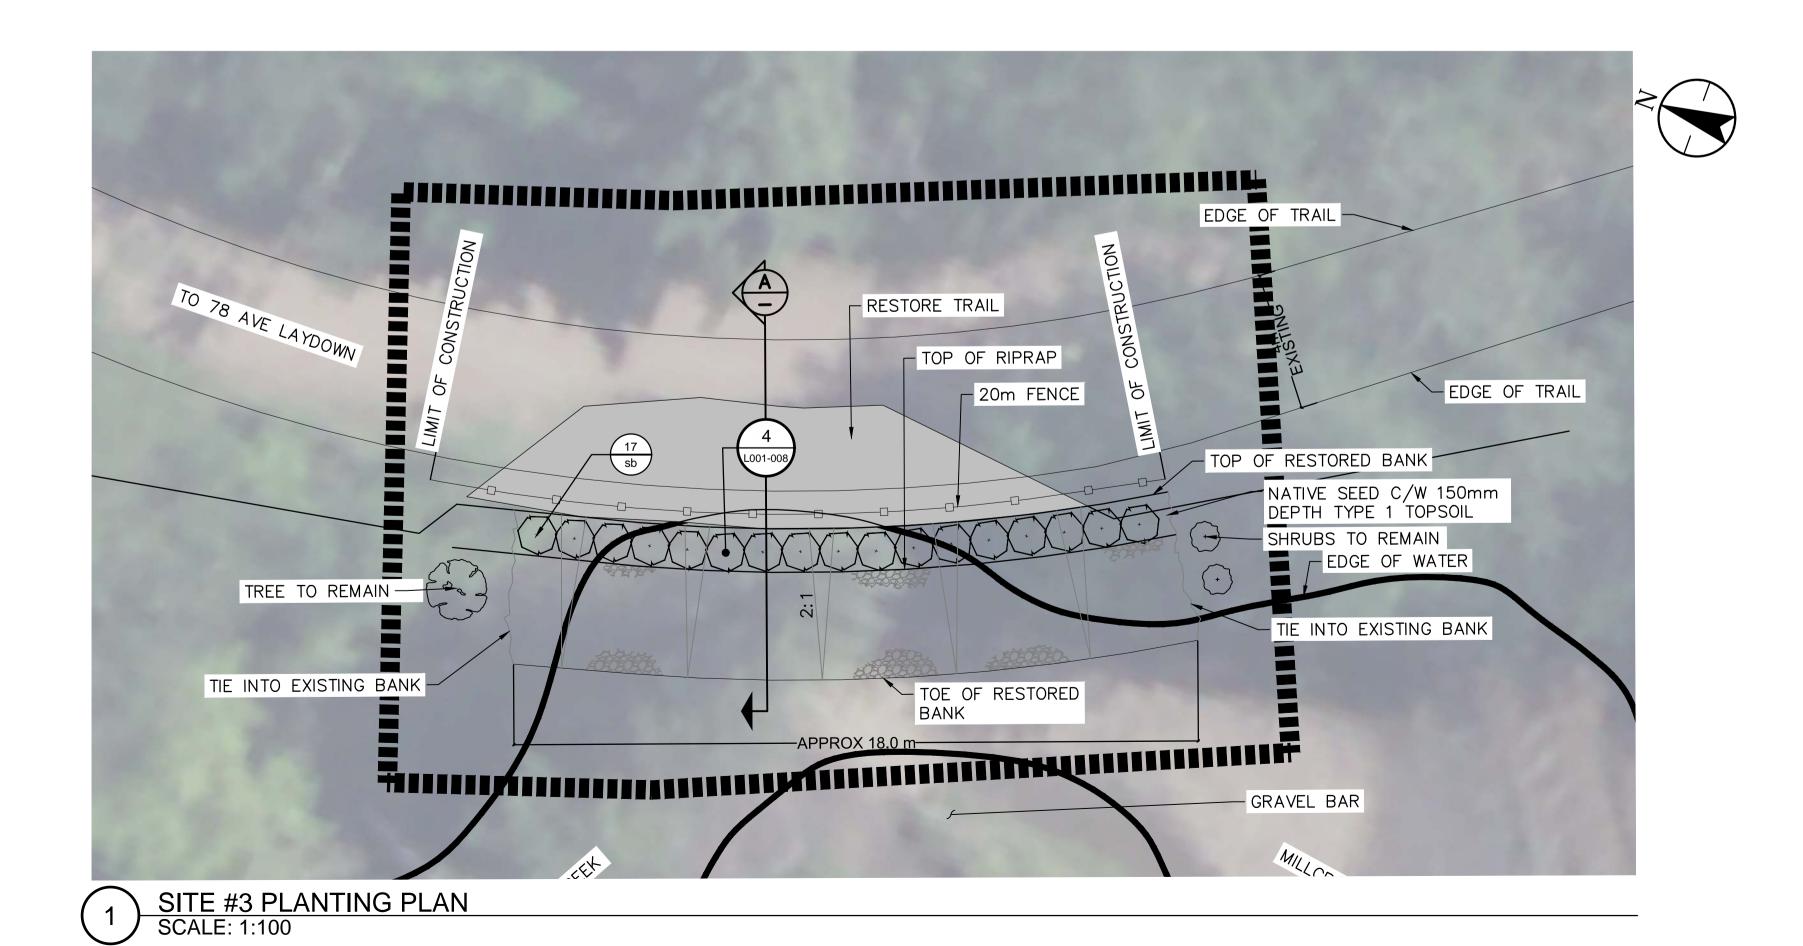




Stantec Consulting Ltd. 10160 - 112 Street Edmonton AB Canada Tel. 780.917.7000 www.stantec.com

Copyright Reserved

The Contractor shall verify and be responsible for all dimensions. DO NOT scale the drawing - any errors or omissions shall be reported to Stantec without delay. The Copyrights to all designs and drawings are the property of Stantec. Reproduction or use for any purpose other than that authorized by Stantec is forbidde

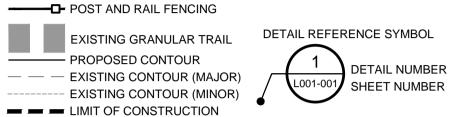

UTILITY SETBACKS

LANDSCAPE CONTRACTOR TO CALL 'ALBERTA ONE-CALL' AT 1-800-242-3447 TO HAVE ALL EXISTING SITE UTILITIES LOCATED PRIOR TO CONSTRUCTION AND PLANT NO CLOSER THAN THE FOLLOWING DIMENSIONS FROM THE SERVICES:

- 1.0 m FROM POWER LINES 3.5 m FROM ALL POWER HARDWARE
- 1.8 m FROM WATER MAINS, WATER VALVES, MANUAL
- AIRVENTS, AND SERVICES 2.0 m FROM SEWER MAINS, AND MANHOLES
- 1.8 m FROM SEWER SERVICES 1.5 m FROM GAS (NO TREES WITHIN EASEMENT)
- 7.5 m FROM STREET CORNERS.
- 3.5 m FROM FIRE HYDRANTS.
- 1.5 m FROM DRIVEWAYS 10. 1.5 m FROM ALLEY ACCESSES
- 11. 1.0 m FROM SIDEWALKS
- OR AS PER APPROVED ENG. CROSS SECTIONS 12. 3.5 m FROM TRANSIT ZONES
- 13. 3.0 m FROM PRIVATE PROPERTY BOUNDARY
- 14. 1.25 m FROM COLLECTOR ROAD CURB FACE
- 15. 1.25 m FROM LOCAL ROAD CURB FACE 16. 2.0 m FROM ARTERIAL ROAD CURB FACE
- 17. 3.5 m FROM YIELD AND STOP SIGNS
- 18. 3.5 m FROM BUS STOP SIGNS
- 19. 2.0 m FROM ALL OTHER SIGNS 20. 1.0 m FROM OTHER UNDERGROUND UTILITIES
- 21. 3.5 m FROM TELUS PEDESTALS
- 22. 2.0 m FROM TELUS DUCT STRUCTURE 23. 1.0 m FROM TELUS CABLE FACILITIES
- LANDSCAPE CONTRACTOR IS RESPONSIBLE FOR DAMAGES AND

Development Engineer, Sustainable Developmen	nt			
Approvals				YY.MM.DD
Revision		Ву	Appd.	YY.MM.DD
1. FIRST SUBMISSION (60%)			NGS	18.05
Issued		Ву	Appd.	YY.MM
File Name: LA_MilCreek.dwg	DW	СВ	NGS	18.03.13
	Dwn.	Chkd.	Dsgn.	YY.MM.DD

Permit-Seal



Client/Project


CITY OF EDMONTON


MILL CREEK RAVINE PARK TRAIL REHABILITATION


Edmonton, Alberta

SITE #3 PLANTING PLAN


1161106255 Drawing No. V:\1161\Active\1161106255\drawing_Landscape\LA_M**ill**Creek.dwg L001-008 2019-3-18 2:02pm BY: DWIGGLESWORTH 8 of 10

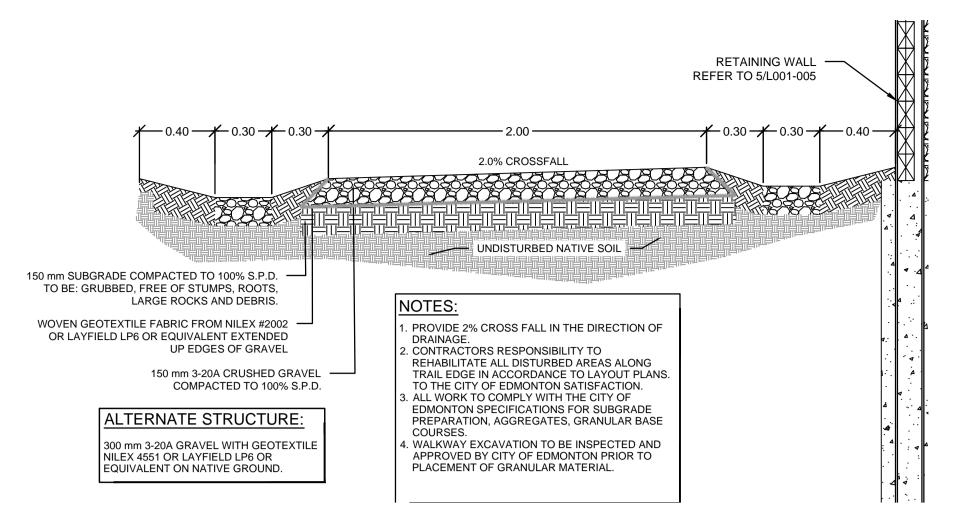

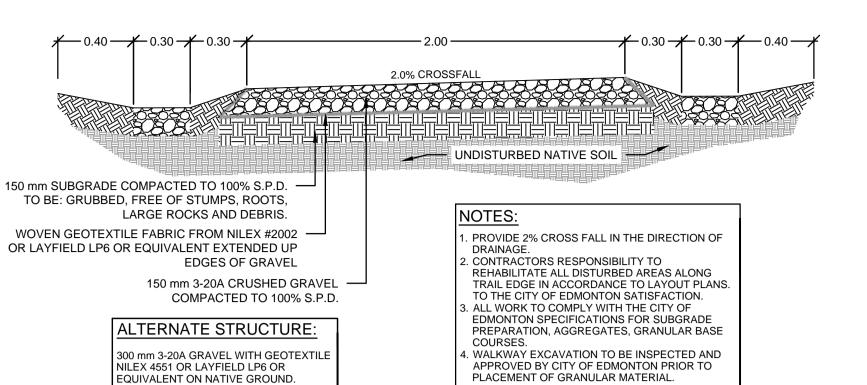


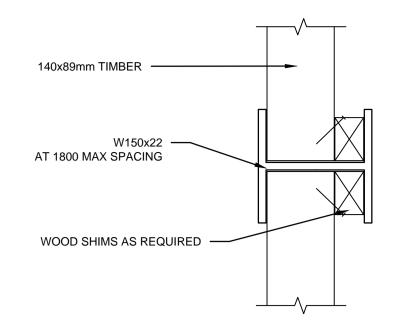

RETAINING WALL SECTION SCALE: 1:5

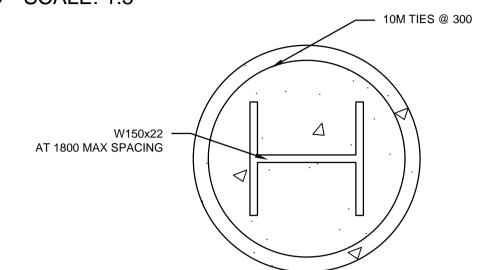


RETAINING WALL SECTION SCALE: 1:5

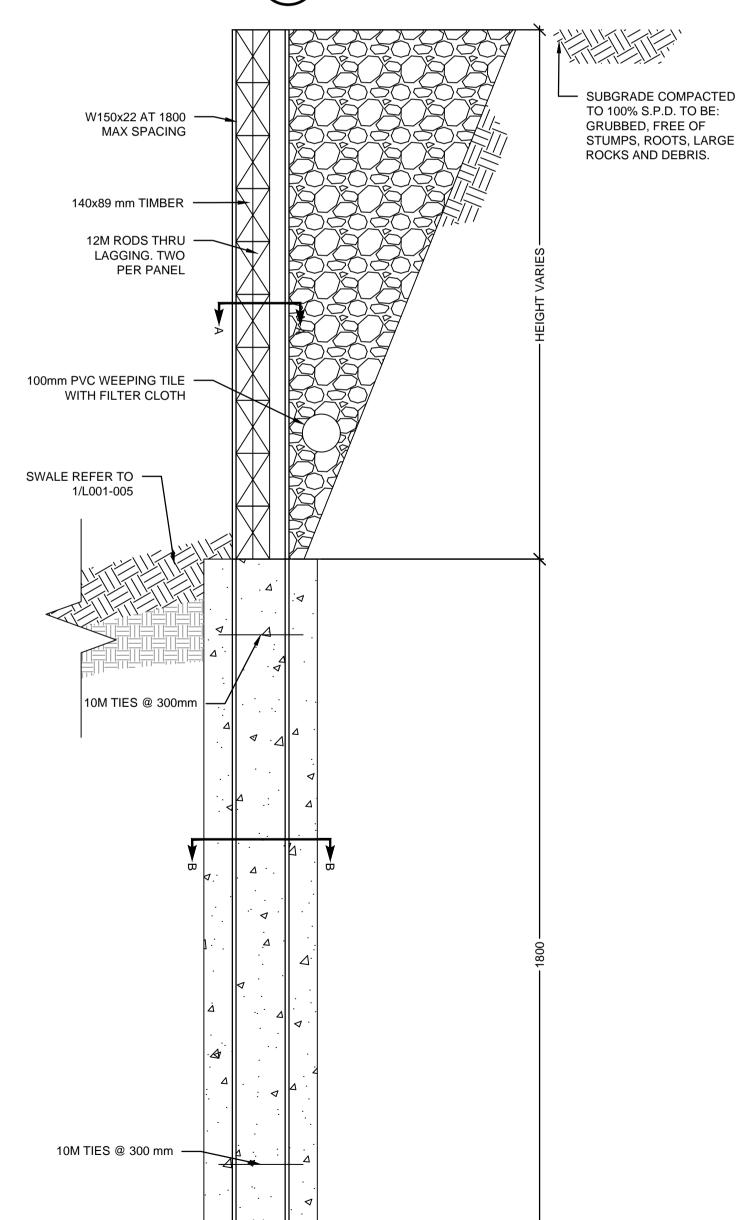


RETAINING WALL ELEVATION SCALE: 1:20

GRANULAR TRAIL WITH RETAINING WALL SCALE: 1:20

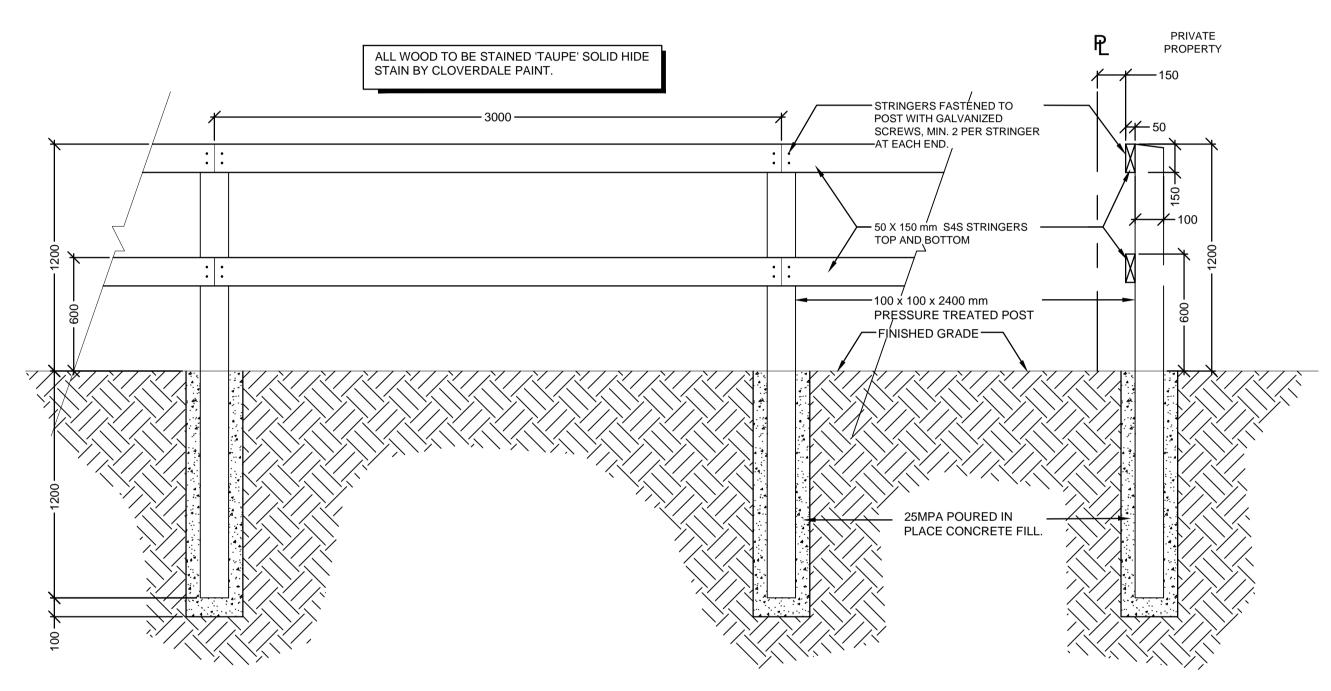

1.2m POST AND RAIL FENCE SCALE: 1:20

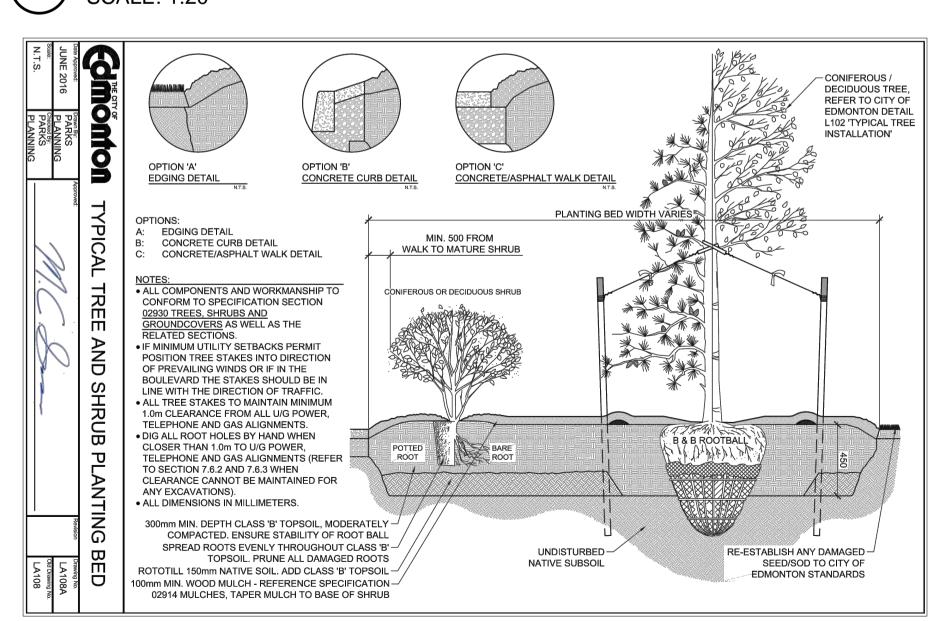

TYPICAL TREE AND SHRUB PLANTING BED SCALE: N.T.S.

RETAINING WALL NOTES:

- WEEPING TILE TO BE 100 mm DIA. PERFORATED POLYVINYL-CHLORIDE PIPE, C/W SOLVENT SEAL COUPLINGS, TEES, ELBOWS, FITTINGS, ETC. FILTER CLOTH TO BE NON-WOVEN POLYESTER SLEEVE EQUAL TO "TREVIRA SPUNBOND NO.1114" AS SUPPLIED BY ARMTEC CONSTRUCTION PRODUCTS. PLACE FILTER CLOTH AROUND PIPE THE BACKFILL WITH GRANULAR FILL. PITCH PIPE $\frac{1}{300}$ TO LOW END OF WALL AND
- DAYLIGHT. BACKFILL TO BE FREE DRAINING PEA GRAVEL LIGHTLY COMPACTED.

NILEX 4551 OR LAYFIELD LP6 OR

EQUIVALENT ON NATIVE GROUND.

GRANULAR TRAIL WITH SWALES
SCALE: 1:20

- DO NOT PROCEED WITH BACKFILLING OPERATIONS UNTIL ENGINEER HAS INSPECTED AND APPROVED
- 4. DO CONCRETE FORMWORK, REINFORCEMENT AND CAST-IN-PLACE CONCRETE IN ACCORDANCE WITH CSA A23.1 EXCEPT WHERE SPECIFIED ELSEWHERE.
- REINFORCED BARS: BILLET STEEL, GRADE 400, DEFORMED BARS TO CAS G30.18-09 EXCEPT BEAM AND COLUMN TIES WHICH SHALL BE GRADE 300.
- IMMEDIATELY FOLLOWING DRILLING OF THE PILE SHAFTS, AND CLEANING INSTALL WIDE FLANGE POST, REINFORCING STEEL AND PLACE CONCRETE.
- PROPORTION NORMAL DENSITY CONCRETE TO CSA A23.1 FOR ALL CONCRETE TO GIVE 25 MPa IN 28 DAYS USING TYPE HS CEMENT, 20 mm COARSE AGGREGATE, 75 mm SLUMP, 5 TO 7% ENTRAINED AIR AND A
- WATER CEMENTING MATERIAL RATIO OF 0.5. 8. STRUCTURAL STEEL TO BE HOT ROLLED SECTIONS TO CAN3 G40.21, 350W.
- 9. SHOP PAINT PRIMER TO CISC/CPMA 1-73Aa. SHOP PRIME TO CAN/CSA-S16-01 ALL STEEL MEMBERS
- EXCEPTING SURFACES IN CONTACT WITH CAST AREAS TO RECEIVE WELDING WORK.
- 10. ALL LUMBER TO BE PRESSURE TREATED SPF No. 1 & 2, OR BETTER.
- 11. BOLTS, NUTS, WASHERS, LAGS, PINS, AND SCREWS TO BE HOT DIP GALVANIZED TO CSA G164.
- 12. WOOD PRESERVATIVE TO BE PENTACHLOROPHENOL BASE WATER REPELLENT WOOD PRESERVATIVE. TREAT CUT ENDS WITH END CUT PRESERVATIVE.



Stantec Consulting Ltd. 10160 - 112 Street Edmonton AB Canada Tel. 780.917.7000 www.stantec.com

Copyright Reserved

UTILITY SETBACKS

1.0 m FROM POWER LINES

AIRVENTS, AND SERVICES

LANDSCAPE CONTRACTOR TO CALL 'ALBERTA ONE-CALL' AT

FOLLOWING DIMENSIONS FROM THE SERVICES:

3.5 m FROM ALL POWER HARDWARE

-800-242-3447 TO HAVE ALL EXISTING SITE UTILITIES LOCATED PRIOR TO CONSTRUCTION AND PLANT NO CLOSER THAN THE

1.8 m FROM WATER MAINS, WATER VALVES, MANUAL

The Contractor shall verify and be responsible for all dimensions. DO NOT scale the drawing - any errors or omissions shall be reported to Stantec without delay. The Copyrights to all designs and drawings are the property of Stantec. Reproduction or use for any purpose other than that authorized by Stantec is forbidde


2.0 m FROM SEWER MAINS, AND 1.8 m FROM SEWER SERVICES 1.5 m FROM GAS (NO TREES WIT) 7.5 m FROM STREET CORNERS. 3.5 m FROM FIRE HYDRANTS. 1.5 m FROM DRIVEWAYS 1.5 m FROM ALLEY ACCESSES 1.0 m FROM SIDEWALKS OR AS PER APPROVED ENG. CRC 3.5 m FROM TRANSIT ZONES 3.0 m FROM PRIVATE PROPERTY 1.25 m FROM COLLECTOR ROAD 1.25 m FROM LOCAL ROAD CURB 2.0 m FROM ARTERIAL ROAD CUI 3.5 m FROM BUS STOP SIGNS 2.0 m FROM ALL OTHER SIGNS 1.0 m FROM OTHER UNDERGROU 3.5 m FROM TELUS PEDESTALS 2.0 m FROM TELUS CABLE FACILI	HIN EAS OSS SEC OSS SEC OUND CURB FA OS FACE RB FACE ONS JND UTIL	EMENT) CTIONS PARY ACE		
NDSCAPE CONTRACTOR IS RESPON BILITIES INCURRED BY DAMAGES T				۱D
velopment Engineer, Sustainable Developmer	nt			
pprovals				YY.MM.DD
vision		Ву	Appd.	YY.MM.DD
FIRST SUBMISSION (60%)		DW	NGS	18.05
Jed		Ву	Appd.	YY.MM
Name: LA_Mi l Creek.dwg	DW	СВ	NGS	18.03.13
<u> </u>	Dwn.	Chkd.	Dsgn.	YY.MM.DD
Na Goulet-	Associate Architecture		of	
ent/Project				
CITY OF EDMONTON				
MILL CREEK RAVINE PATRAIL REHABILITATION Edmonton, Alberta	4RK			
DETAILS				

Scale

Project No.

1161106255

AS SHOWN Drawing No. $\label{thm:linear_lambda} V:\label{linear_lambda} V:\label{linear_lambda} V:\label{linear_lambda} I \label{linear_lambda} Active \label{linear_lambda} I \label{linear_lambda} V:\label{linear_lambda} I \label{linear_lambda} I \label{linear_lambd$ L001-009 2019-3-18 2:03pm BY: DWIGGLESWORTH 9 of 10

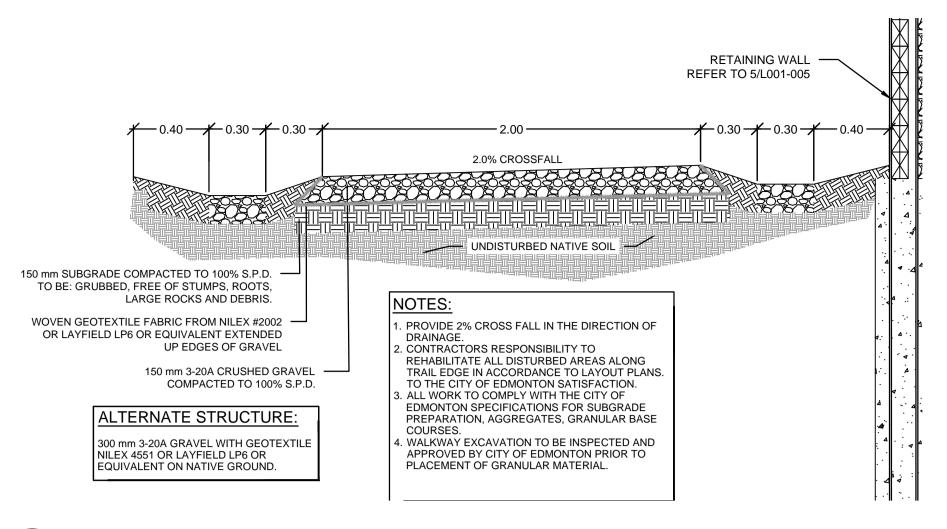

1 GRANULAR TRAIL WITH RETAINING WALL SCALE: 1:20



Stantec Consulting Ltd. 10160 - 112 Street Edmonton AB Canada Tel. 780.917.7000 www.stantec.com

Copyright Reserved

The Contractor shall verify and be responsible for all dimensions. DO NOT scale the drawing - any errors or omissions shall be reported to Stantec without delay. The Copyrights to all designs and drawings are the property of Stantec. Reproduction or use for any purpose other than that authorized by Stantec is forbidde

egend

Note	2 S
UT	ILITY SETBACKS
	SCAPE CONTRACTOR TO CALL 'ALBERTA ONE-CALL' AT
)-242-3447 TO HAVE ALL EXISTING SITE UTILITIES LOCATE OR TO CONSTRUCTION AND PLANT NO CLOSER THAN THE
	OWING DIMENSIONS FROM THE SERVICES:
1.	1.0 m FROM POWER LINES
2.	3.5 m FROM ALL POWER HARDWARE
3.	1.8 m FROM WATER MAINS, WATER VALVES, MANUAL
	AIRVENTS, AND SERVICES
4.	2.0 m FROM SEWER MAINS, AND MANHOLES
5.	1.8 m FROM SEWER SERVICES
6.	1.5 m FROM GAS (NO TREES WITHIN EASEMENT)
7.	7.5 m FROM STREET CORNERS.

11. 1.0 m FROM SIDEWALKS
OR AS PER APPROVED ENG. CROSS SECTIONS
12. 3.5 m FROM TRANSIT ZONES
13. 3.0 m FROM PRIVATE PROPERTY BOUNDARY

14. 1.25 m FROM COLLECTOR ROAD CURB FACE
15. 1.25 m FROM LOCAL ROAD CURB FACE
16. 2.0 m FROM ARTERIAL ROAD CURB FACE

16. 2.0 m FROM ARTERIAL ROAD CURB FACE
17. 3.5 m FROM YIELD AND STOP SIGNS

18. 3.5 m FROM BUS STOP SIGNS
19. 2.0 m FROM ALL OTHER SIGNS
20. 1.0 m FROM OTHER UNDERGROUND UTILITIES

3.5 m FROM FIRE HYDRANTS.
 1.5 m FROM DRIVEWAYS
 1.5 m FROM ALLEY ACCESSES

21. 3.5 m FROM TELUS PEDESTALS

22. 2.0 m FROM TELUS DUCT STRUCTURE
23. 1.0 m FROM TELUS CABLE FACILITIES

LANDSCAPE CONTRACTOR IS RESPONSIBLE FOR DAMAGES AND LIABILITIES INCURRED BY DAMAGES TO SITE UTILITIES.

Approvals				YY.MM.DD
Αρριοναίδ				
Revision		Ву	Appd.	YY.MM.DE
TIPOT CURVICOLONI (1007)				10.05
1. FIRST SUBMISSION (60%)		DW	NGS	18.05
Issued		Ву	Appd.	YY.MM
File Name: LA_MilCreek.dwg	DW	СВ	NGS	18.03.13

Permit-Seal



Client/Project

CITY OF EDMONTON

MILL CREEK RAVINE PARK TRAIL REHABILITATION

Edmonton, Alberta

tle DETAILS

Project No. Scale
1161106255 AS SHOWN

V:\1161\Active\1161106255\drawing_Landscape\LA_MillCreek.dwg

2019-3-18 2:03pm BY: DWIGGLESWORTH 10 of 10

L001-010

Drawing No.